# Proposed Ardderroo Wind Farm Development, Co. Galway


Planning Permission Application Drawings





Planning & Environmental Consultants


### **Schedule of Drawings**


Drawing No.	Drawing Title	Scale
0815 – 01	Location Context Map	1:50,000
0815 – 02	Site Location Map	1:50,000
0815 – 03	Site Layout (1:5,000) Key Plan	1:12,500
0815 – 04	Site Layout Plan – Sheet 1 of 3	1:5,000
0815 – 05	Site Layout Plan – Sheet 2 of 3	1:5,000
0815 – 06	Site Layout Plan – Sheet 3 of 3	1:5,000
0815 – 07	Site Layout (1:2,500) Key Plan	1:12,500
0815 – 08	Site Layout Plan - Sheet 1 of 12	1:2,500
0815 – 09	Site Layout Plan - Sheet 2 of 12	1:2,500
0815 – 10 0815 – 11	Site Layout Plan - Sheet 4 of 12	1:2,500
0815 - 11 $0815 - 12$	Site Layout Plan - Sheet 4 of 12 Site Layout Plan - Sheet 5 of 12	1:2,500 1:2,500
0815 – 12 0815 – 13	Site Layout Plan - Sheet 6 of 12	1:2,500
0815 – 14	Site Layout Plan - Sheet 7 of 12	1:2,500
0815 – 15	Site Layout Plan - Sheet 8 of 12	1:2,500
0815 – 16	Site Layout Plan - Sheet 9 of 12	1:2,500
0815 – 17	Site Layout Plan - Sheet 10 of 12	1:2,500
0815 – 18	Site Layout Plan - Sheet 11 of 12	1:2,500
0815 – 19	Site Layout Plan - Sheet 12 of 12	1:2,500
0815 – 20	Drainage Layout Sheet 1 of 10	1:2,000
0815 – 21	Drainage Layout Sheet 2 of 10	1:2,000
0815 – 22	Drainage Layout Sheet 3 of 10	1:2,000
0815 – 23	Drainage Layout Sheet 4 of 10	1:2,000
0815 – 24	Drainage Layout Sheet 5 of 10	1:2,000
0815 – 25	Drainage Layout Sheet 6 of 10	1:2,000
0815 – 26	Drainage Layout Sheet 7 of 10	1:2,000
0815 – 27	Drainage Layout Sheet 8 of 10	1:2,000
0815 – 28	Drainage Layout Sheet 9 of 10	1:2,000
0815 – 29 0815 – 30	Drainage Layout Sheet 10 of 10 Drainage Details 1	1:2,000 As Shown
0815 - 30 $0815 - 31$	Drainage Details 1  Drainage Details 2	As Shown
	Drainage Details 3	As Shown
0815 - 33	Drainage Details 4	As Shown
0815 - 34	Temporary Construction Compound 1	1:500
0815 – 35	Temporary Construction Compound 2	1:500
0815 – 36	Site Substation Layout	1:500
0815 – 37	Site Substation Front Elevation – South East	1:200
0815 – 38	Site Substation Section A-A	1:200
0815 – 39	Site Substation Side Elevation – South West	1:200
0815 – 40	Control Building 1 Elevations & Section	1:100
0815 – 41	Control Building 2 Elevations & Section	1:100
0815 – 42	Borrow Pit 1 Layout and Section	As Shown
0815 – 43	Borrow Pit 2 Layout and Section	As Shown
0815 – 44	Borrow Pit 3 Layout and Section	As Shown
0815 – 45 0815 – 46	Free Standing Anemometry Mast Turbine Hardstand Layout Standard Detail	1:500 1:500
0815 - 46 $0815 - 47$	Wind Turbine Elevation & Plan	1:500
0815 - 47 $0815 - 48$	Road Type A - Upgrade of Existing Excavated Access Track	1:50
0815 – 49	Road Type B - Upgrade of Existing Floated Access Track	1:50
0815 – 50	Road Type C - New Excavate & Replace Access Road	1:50
0815 – 51	Road Type D - New Floated Access Road	1:50
0815 – 52	Proposed Amenity & Recreation Car Park	1:250
0815 – 53	Toilets Layout & Elevations	1:50
0815 – 54	Amenity Area Signage	1:20
0815 – 55	Typical Clear Span Watercourse Crossing Detail & Cross Section	1:100
0815 – 56	Typical Joint Bay Details - Sheet 1 of 3	1:25
0815 – 57	Typical Joint Bay Details - Sheet 2 of 3	1:25
0815 – 58	Typical Joint Bay Details - Sheet 3 of 3	1:25
0815 – 59	Typical Comms Chamber Detail	1:20
0815 – 60	Roadside Cable Trench Cross Section	1:10
001E C1	Cable Trench Under Service/Crossing Flatbed Formation Cable Trench Over Service/Crossing Flatbed Formation	1:25 1:25
0815 - 61		11.20
0815 – 62	5	
0815 – 62 0815 – 63	Cable Trench Flatbed at Road Surface Level	As Shown
0815 - 62 0815 - 63 0815 - 64	Cable Trench Flatbed at Road Surface Level Cable Trench Under Service/Crossing Trefoil Formation	As Shown 1:25
0815 – 62 0815 – 63	Cable Trench Flatbed at Road Surface Level	As Shown

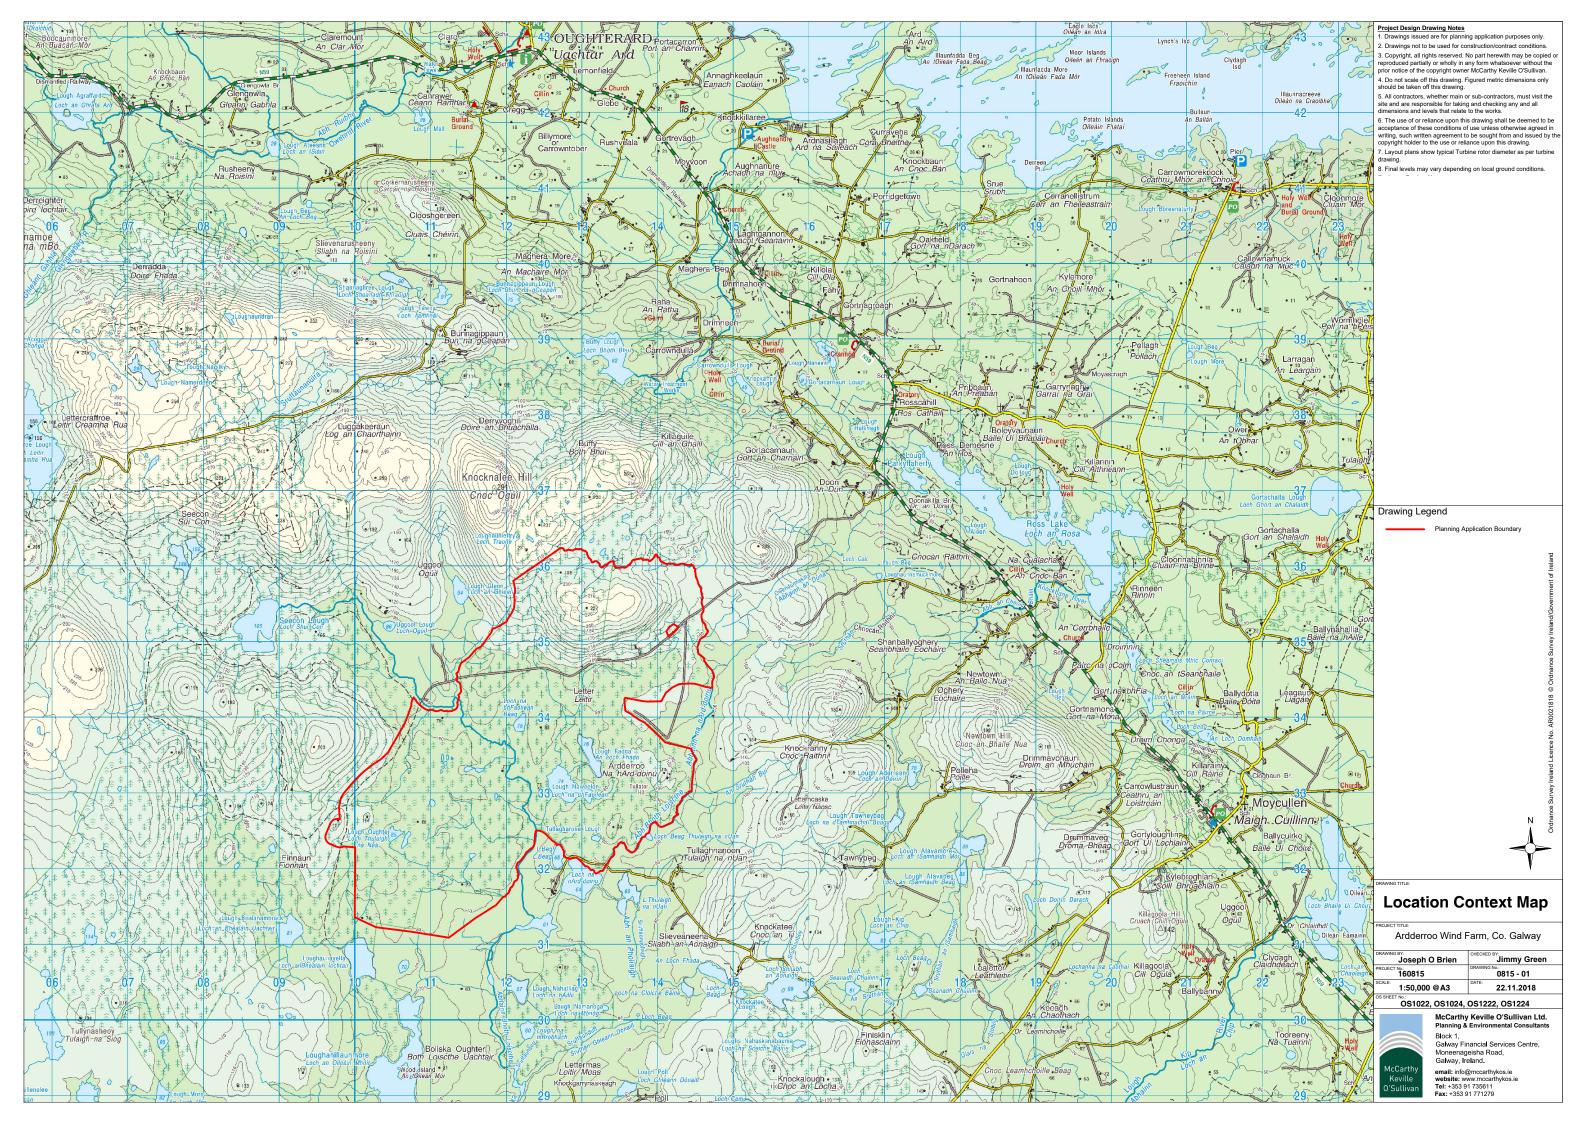


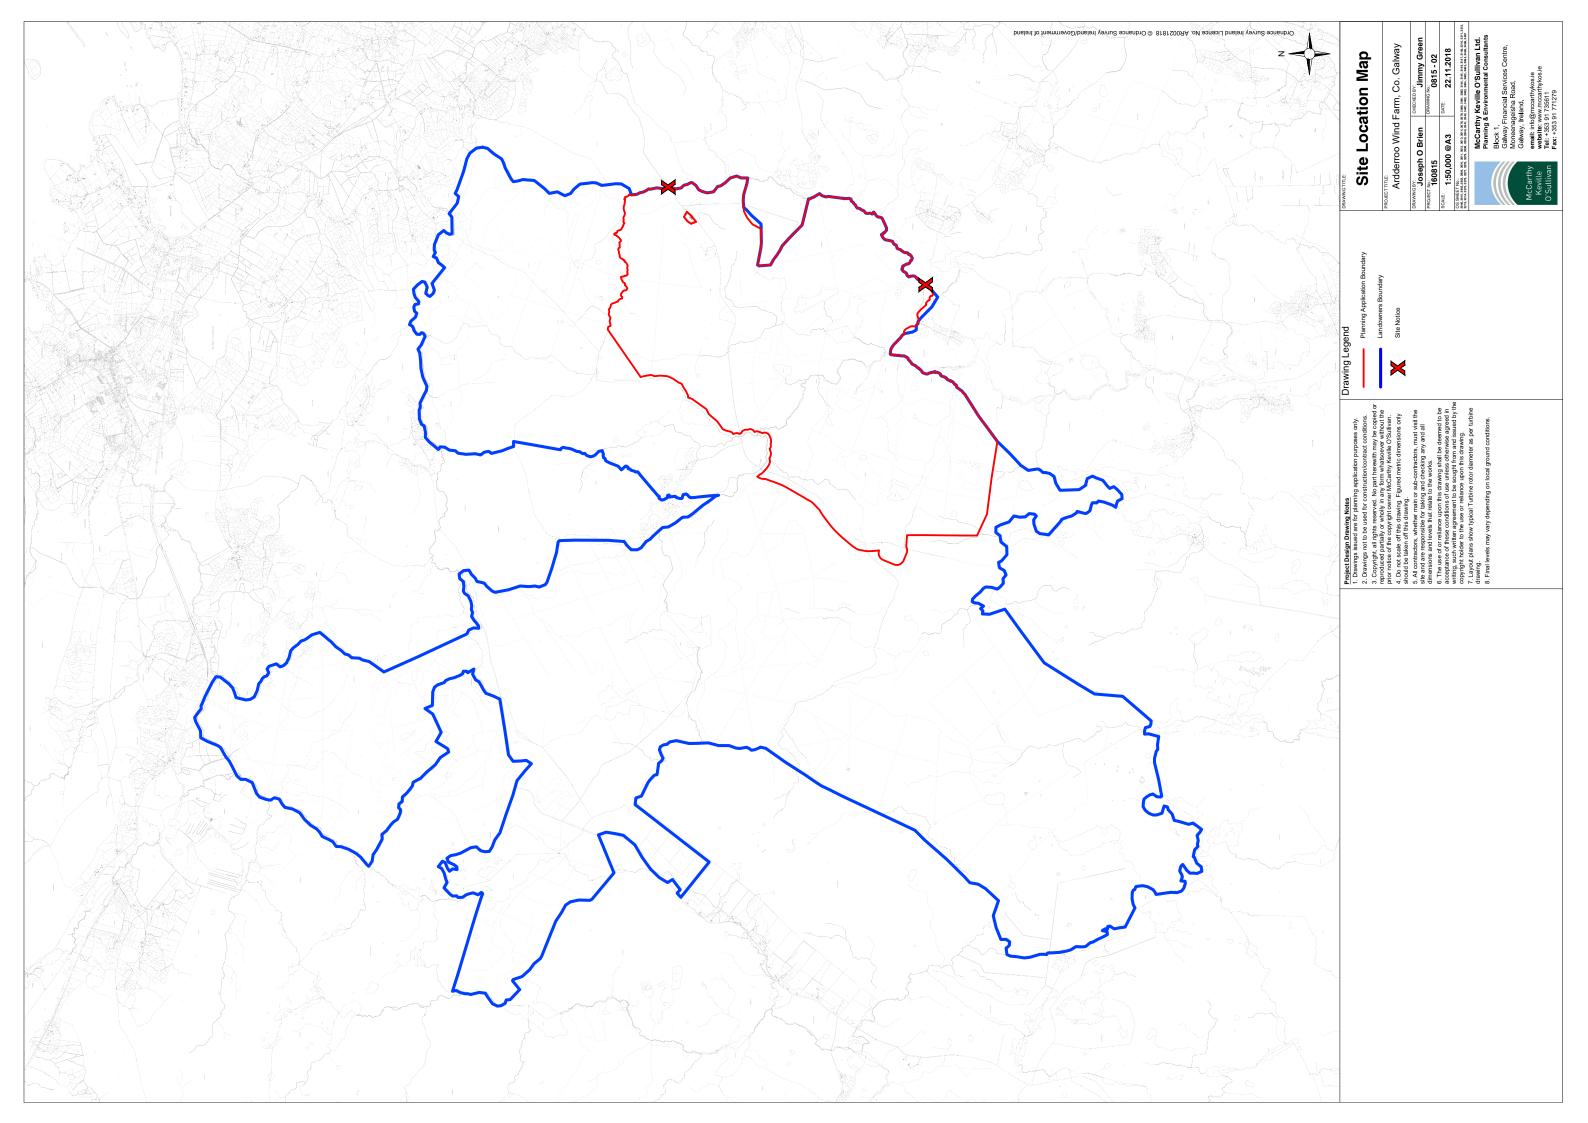


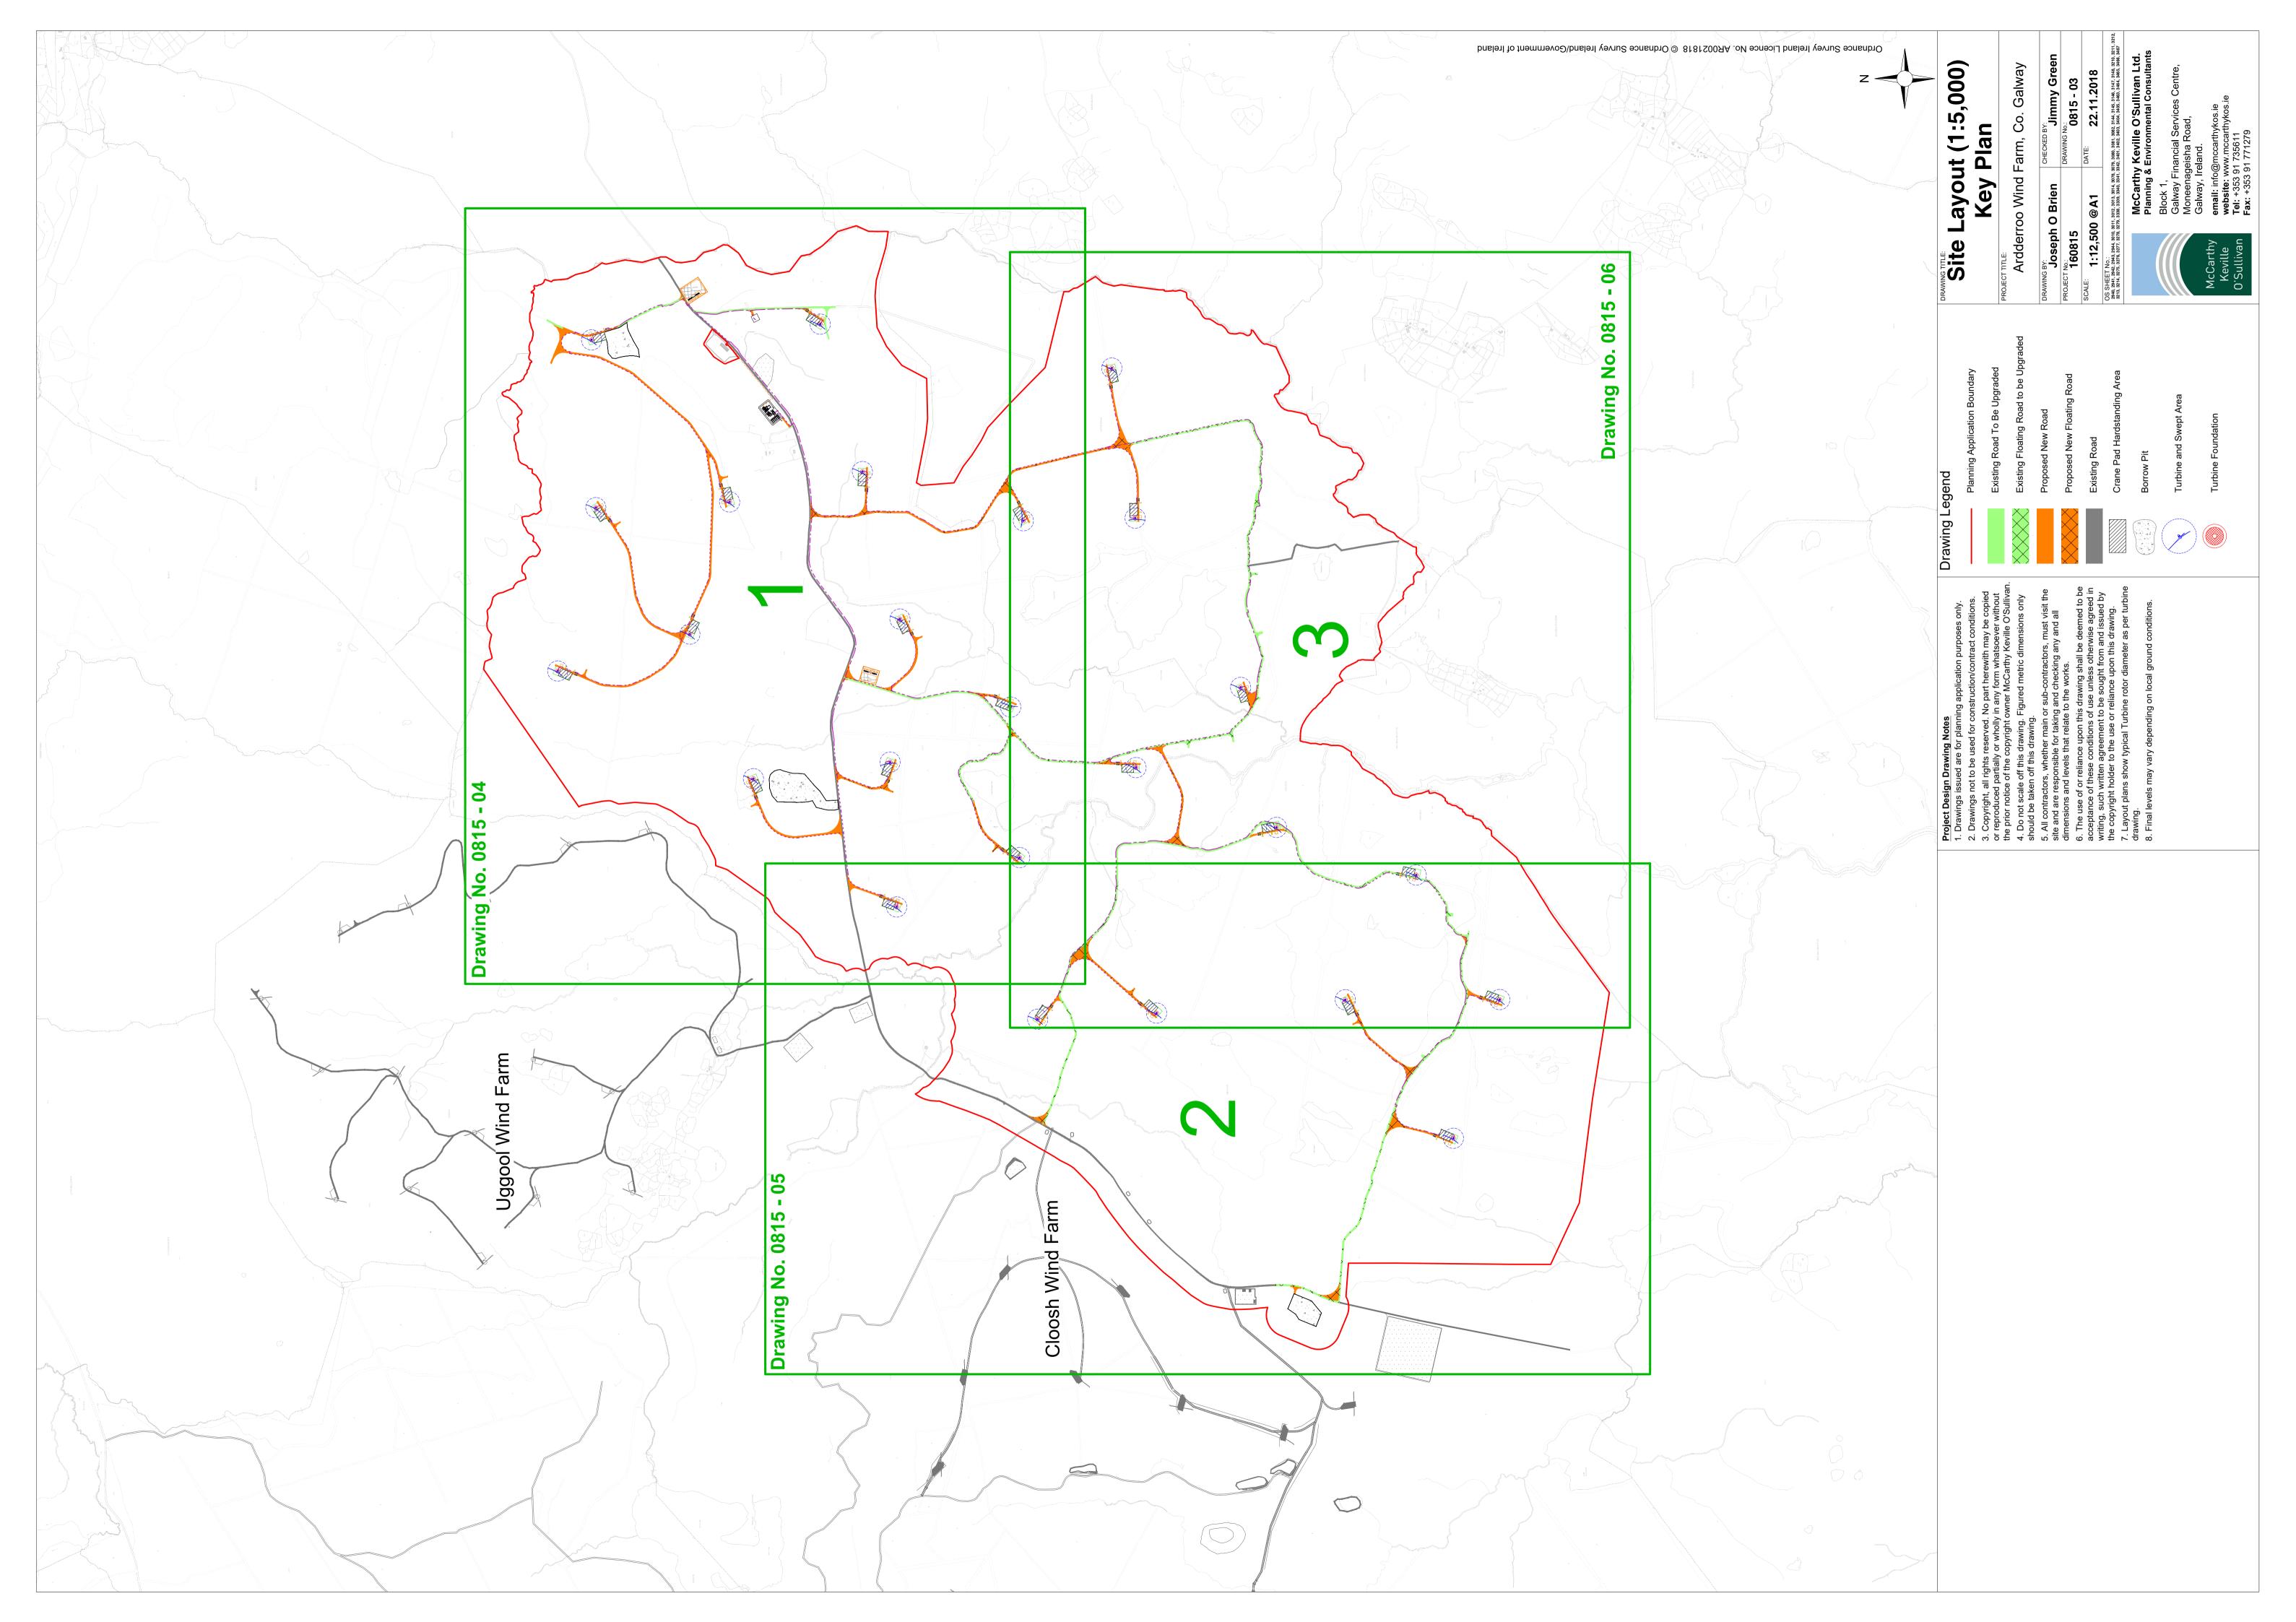


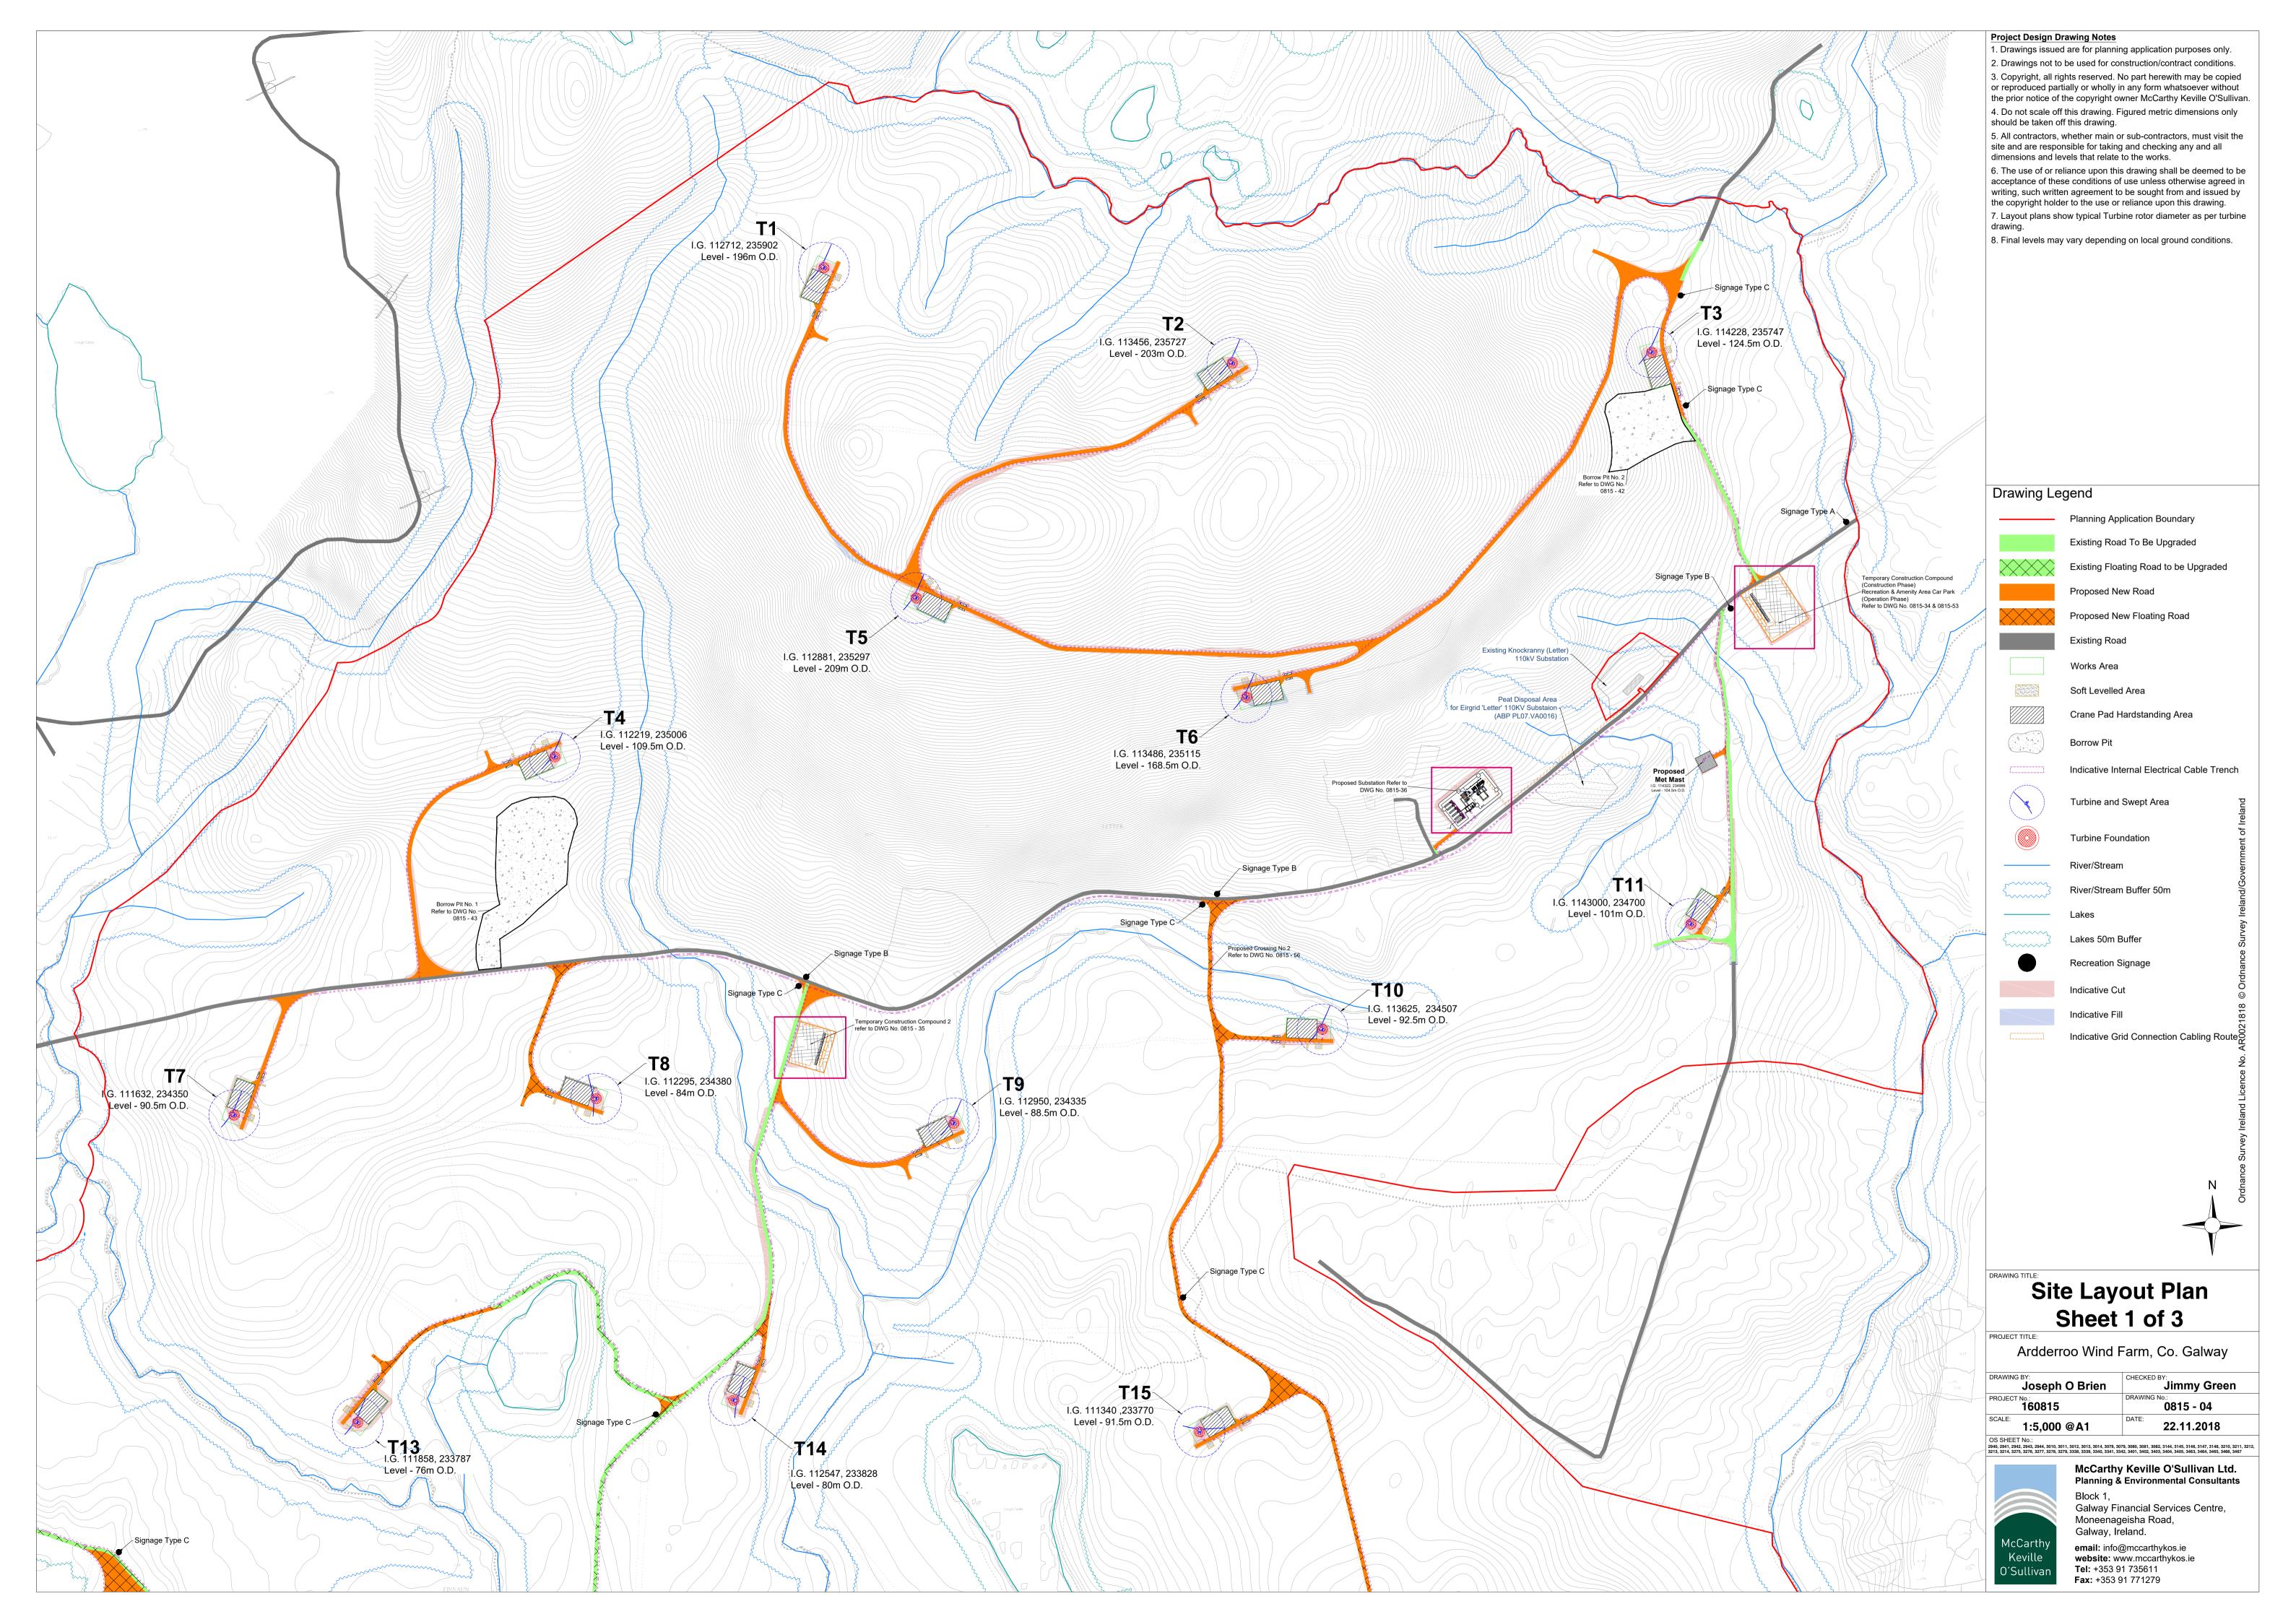


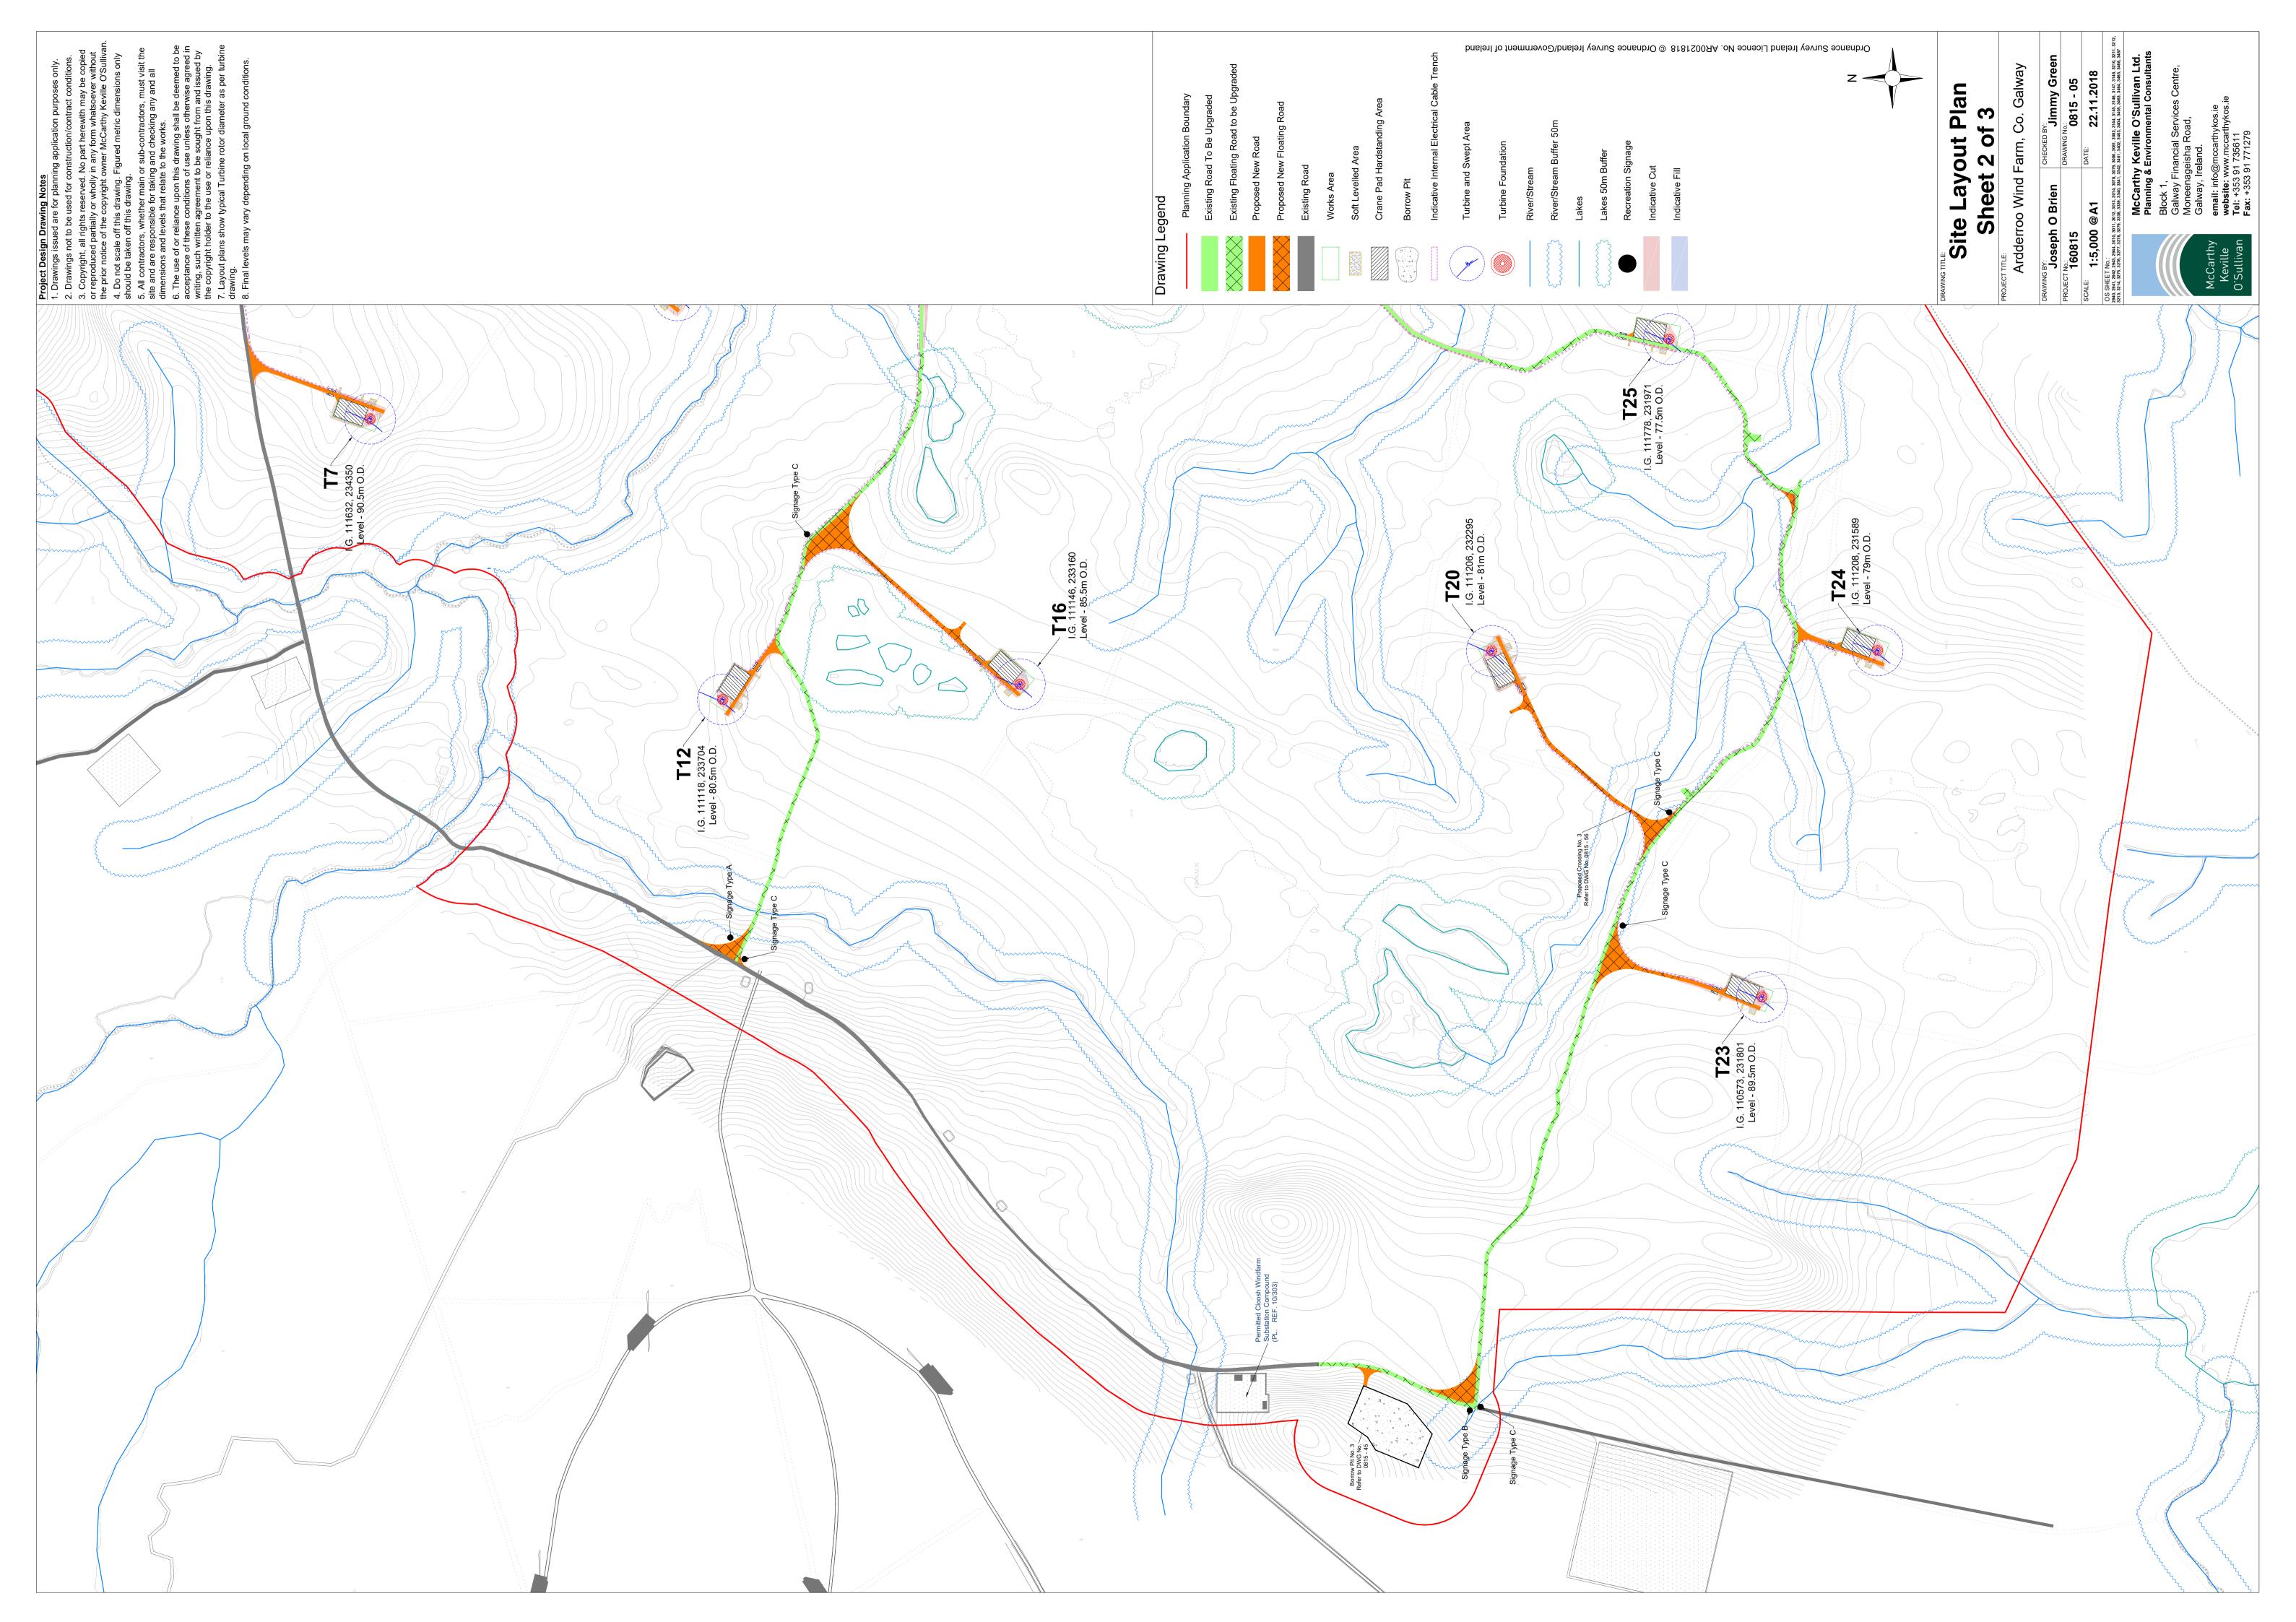


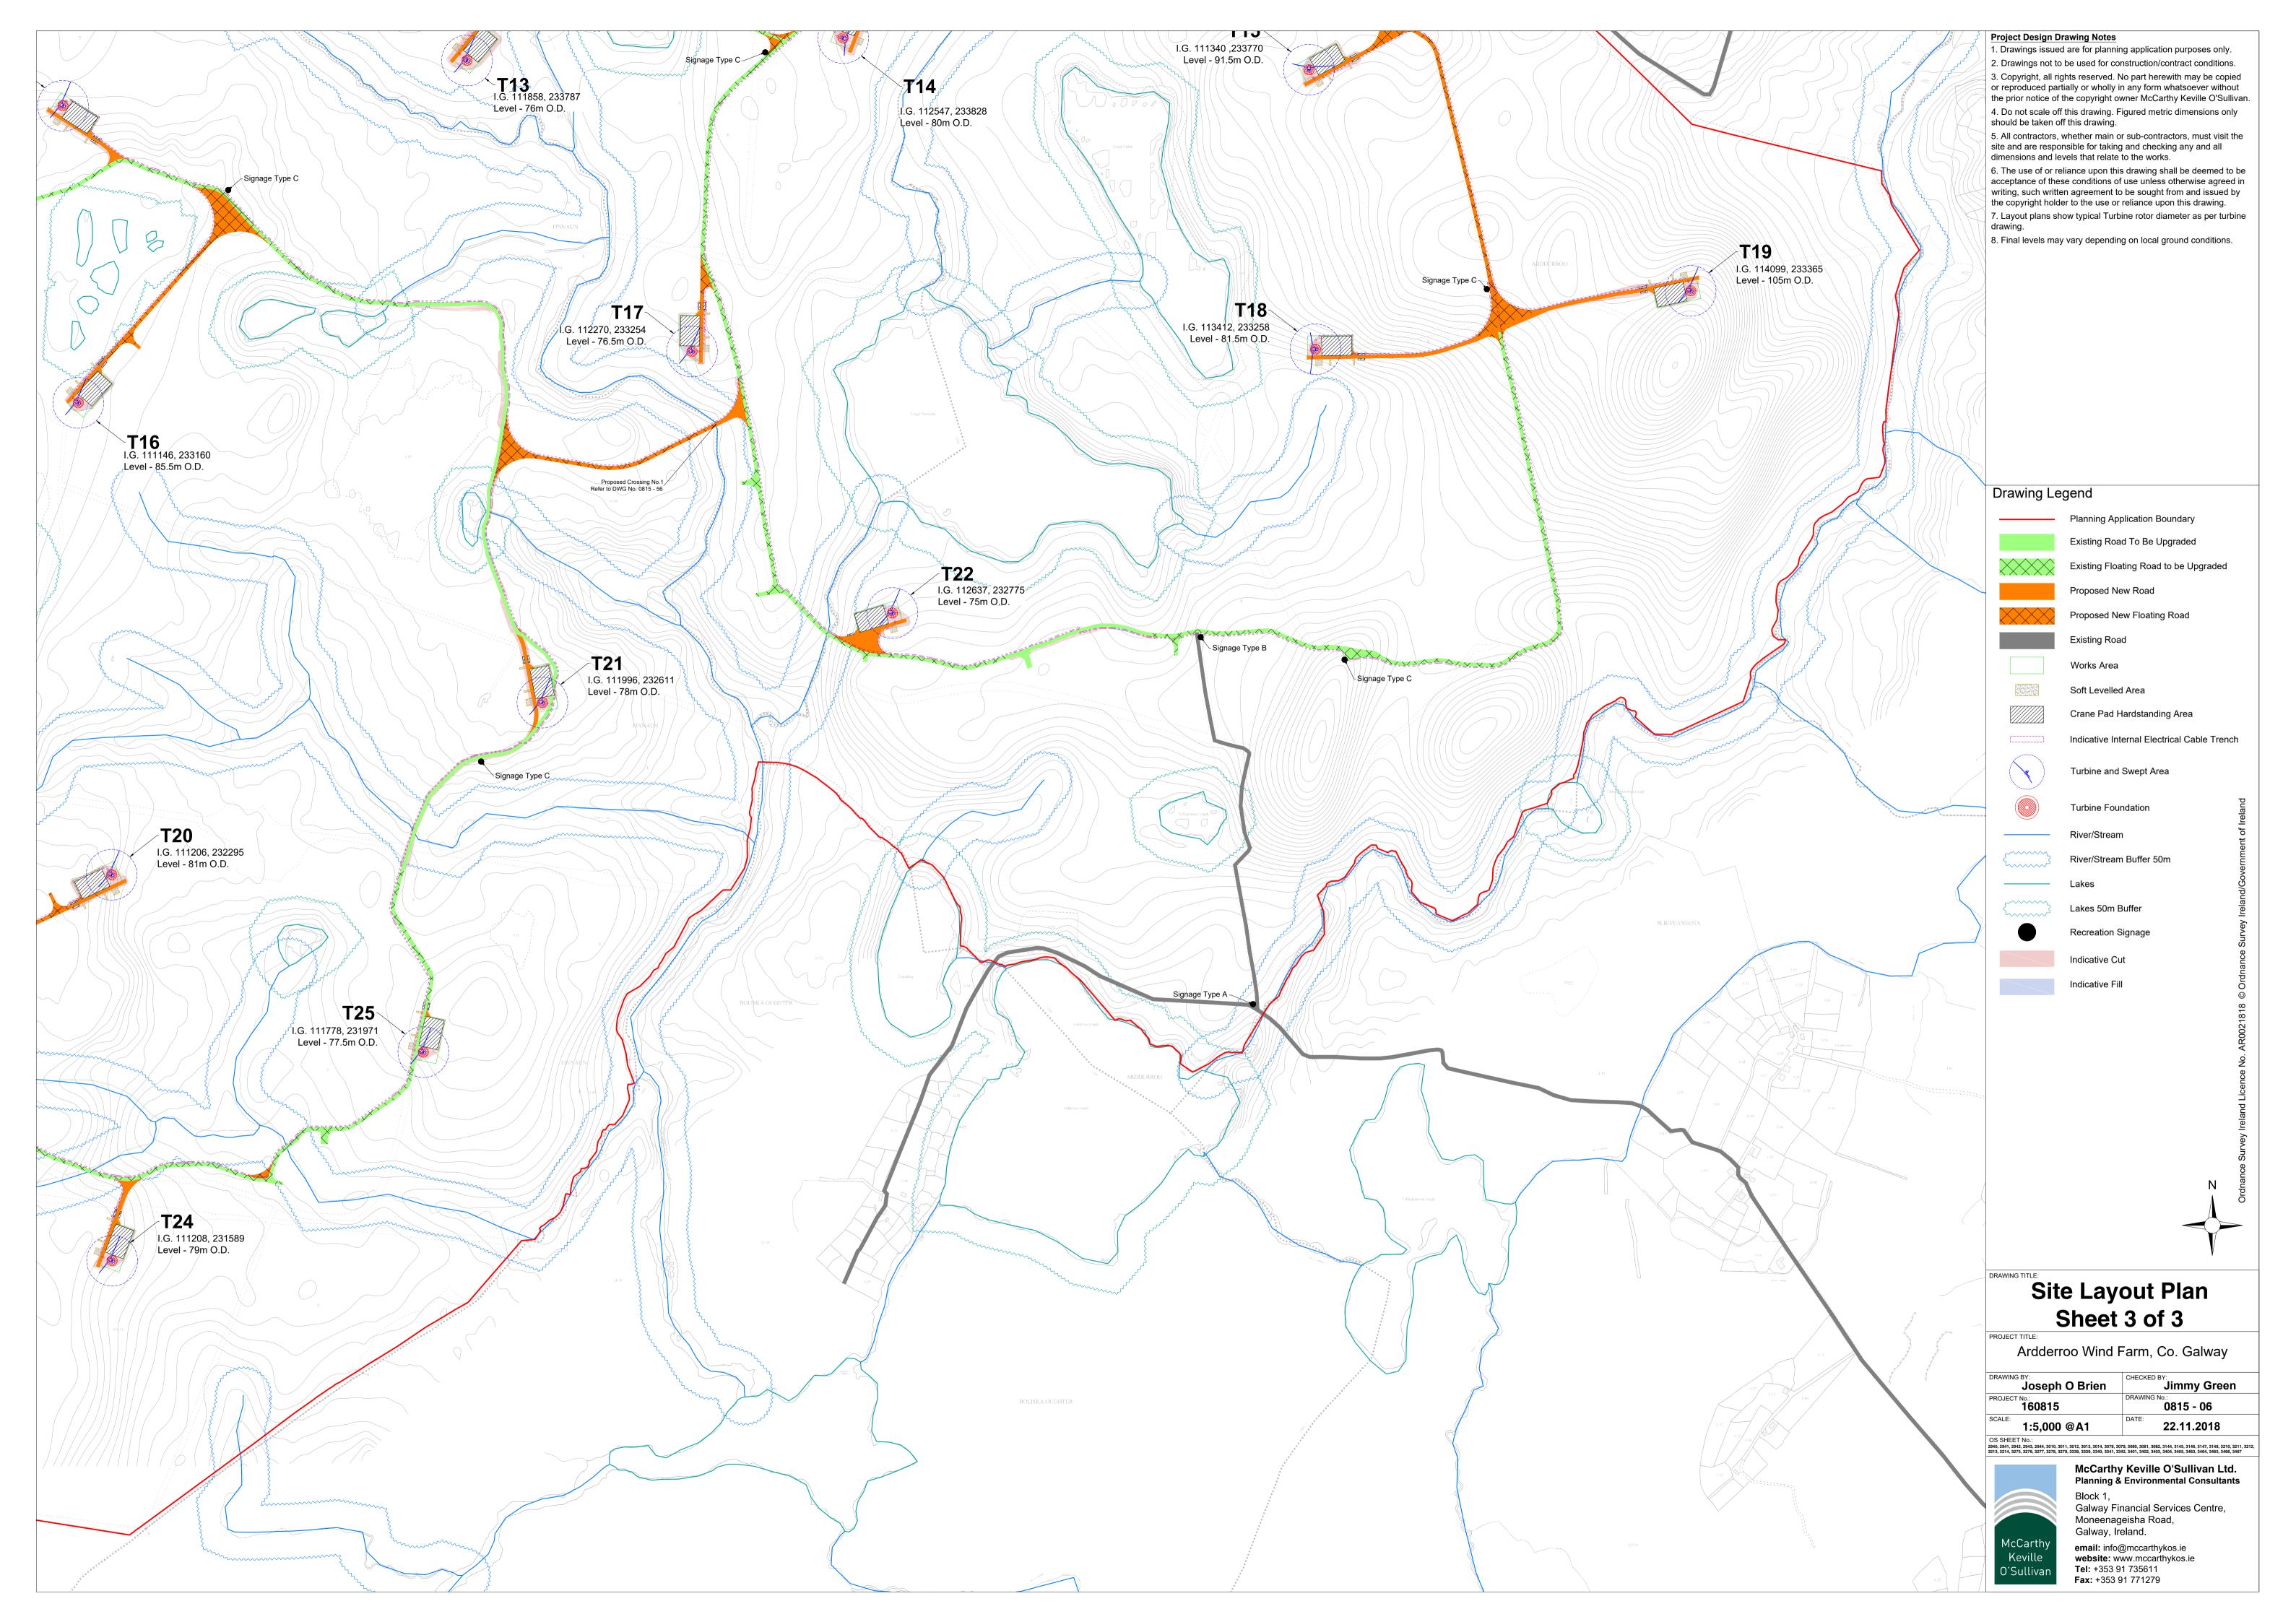


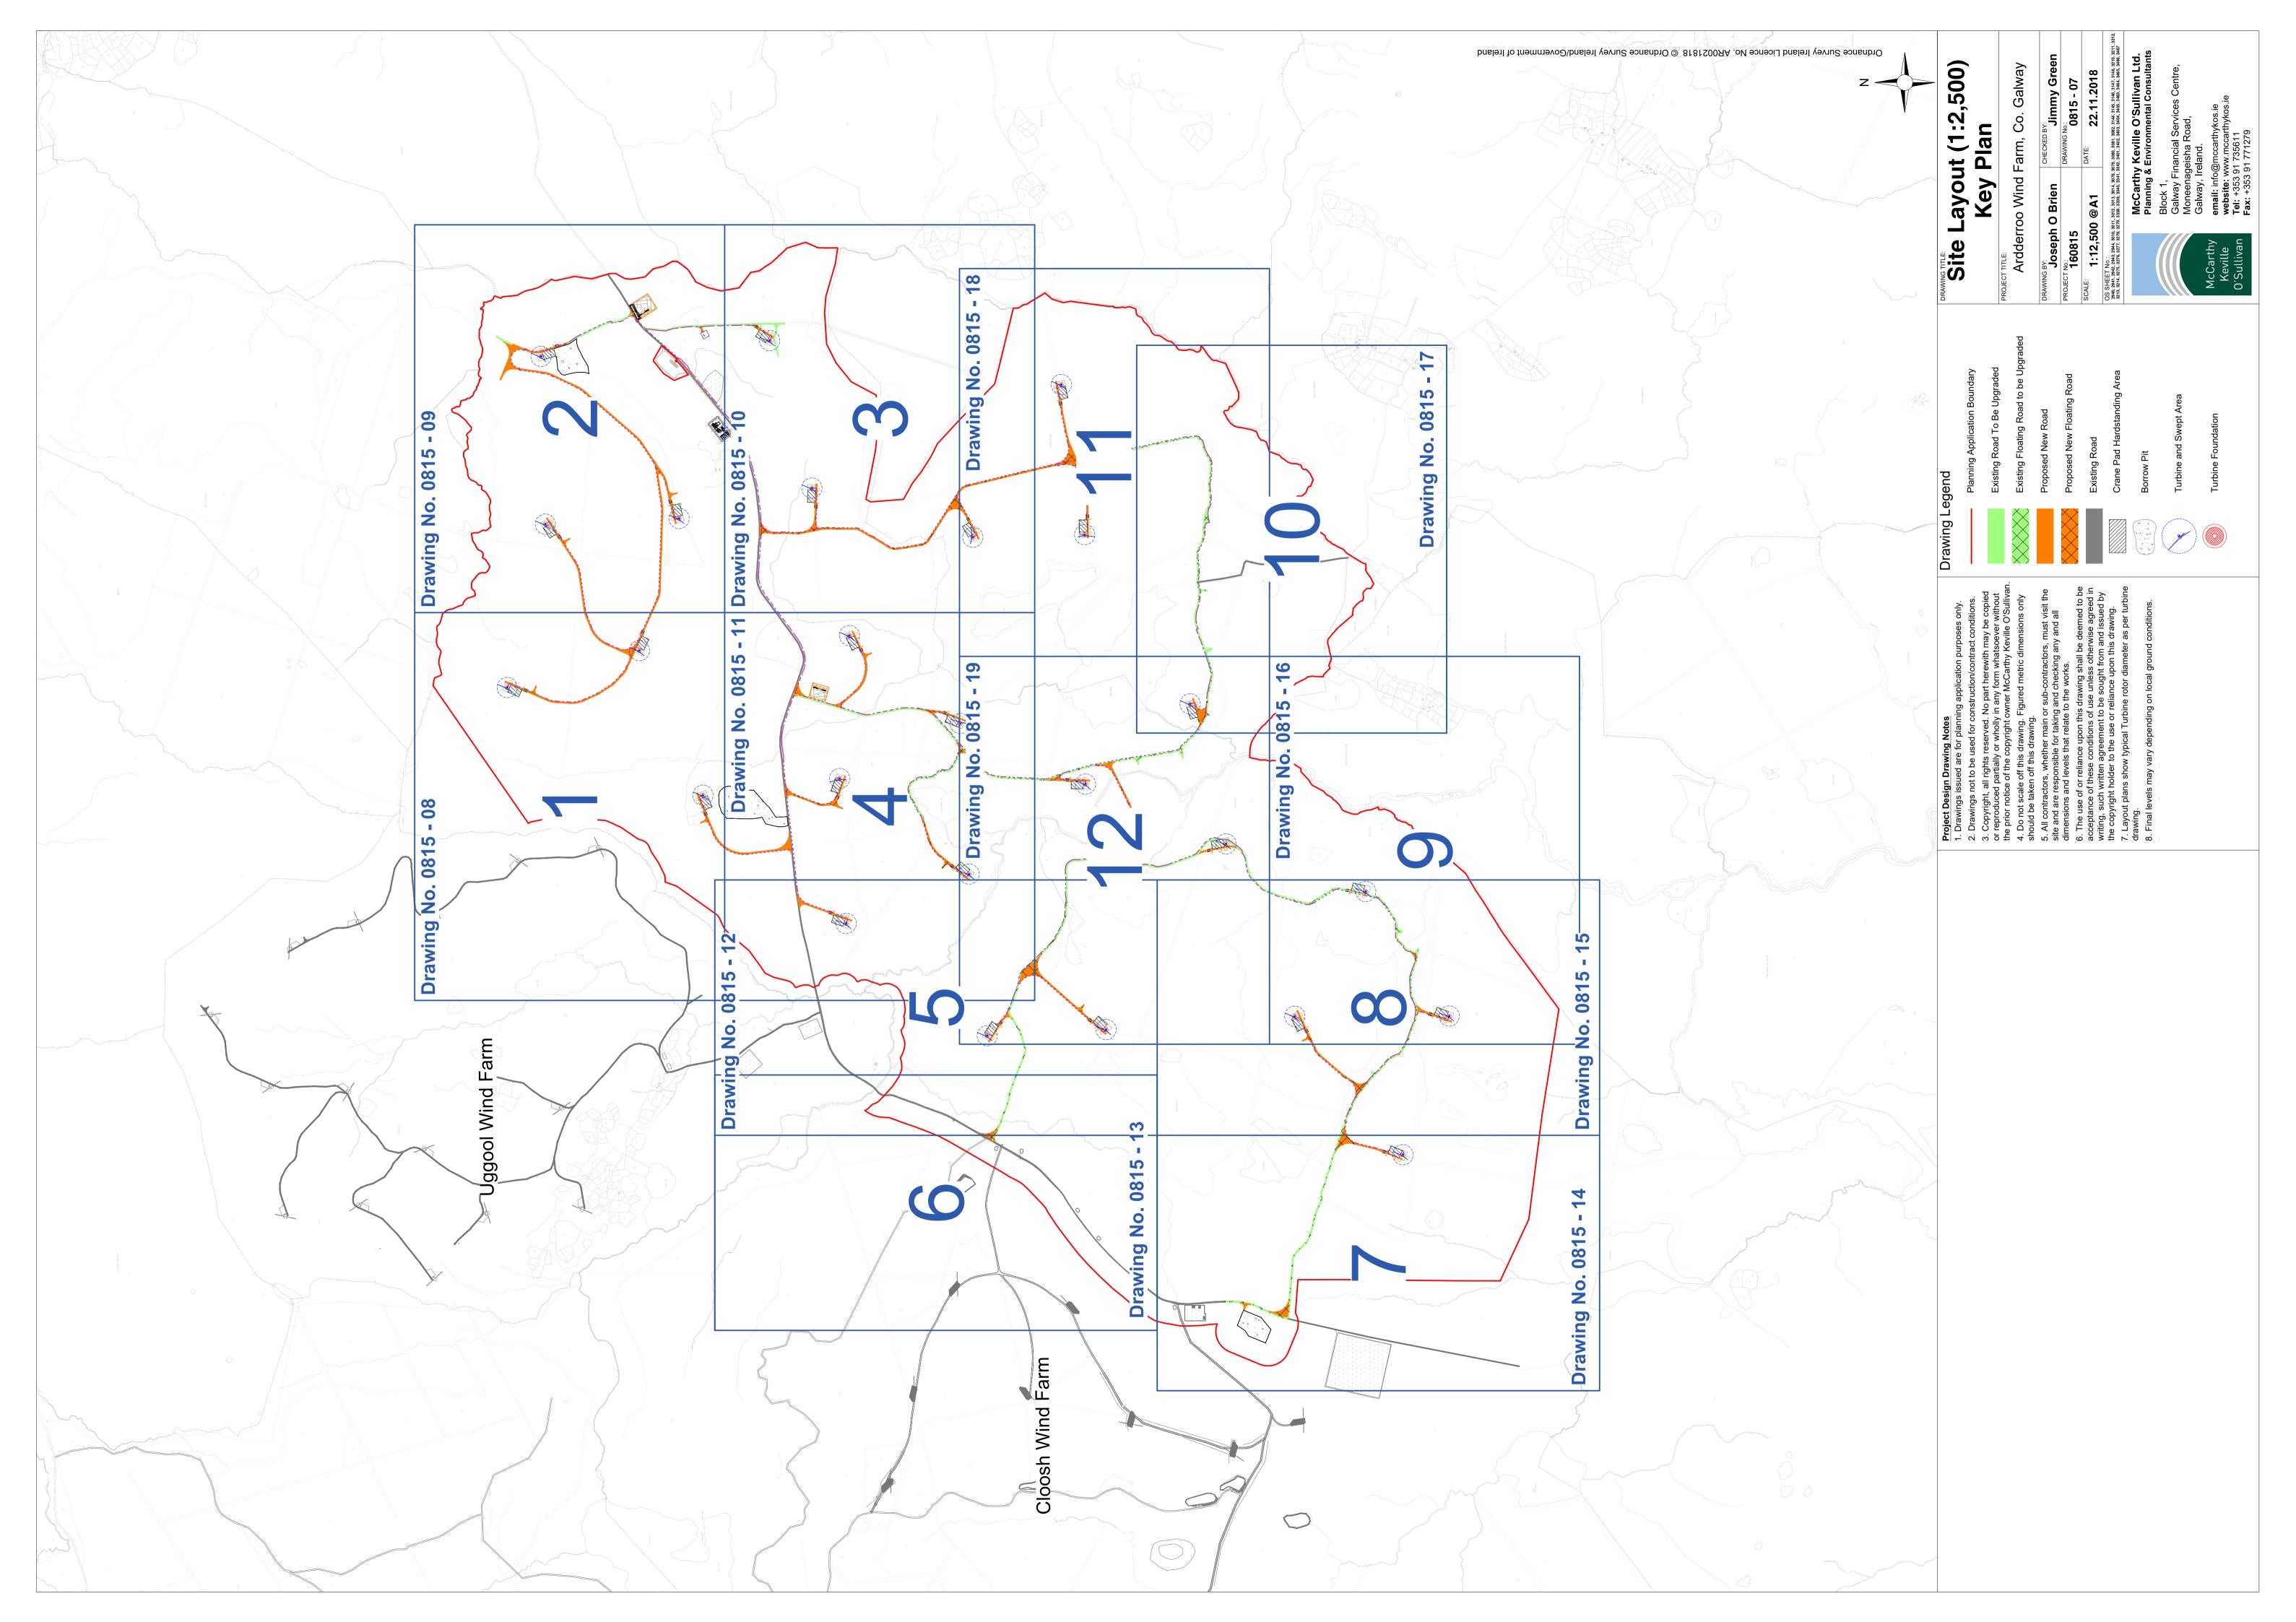


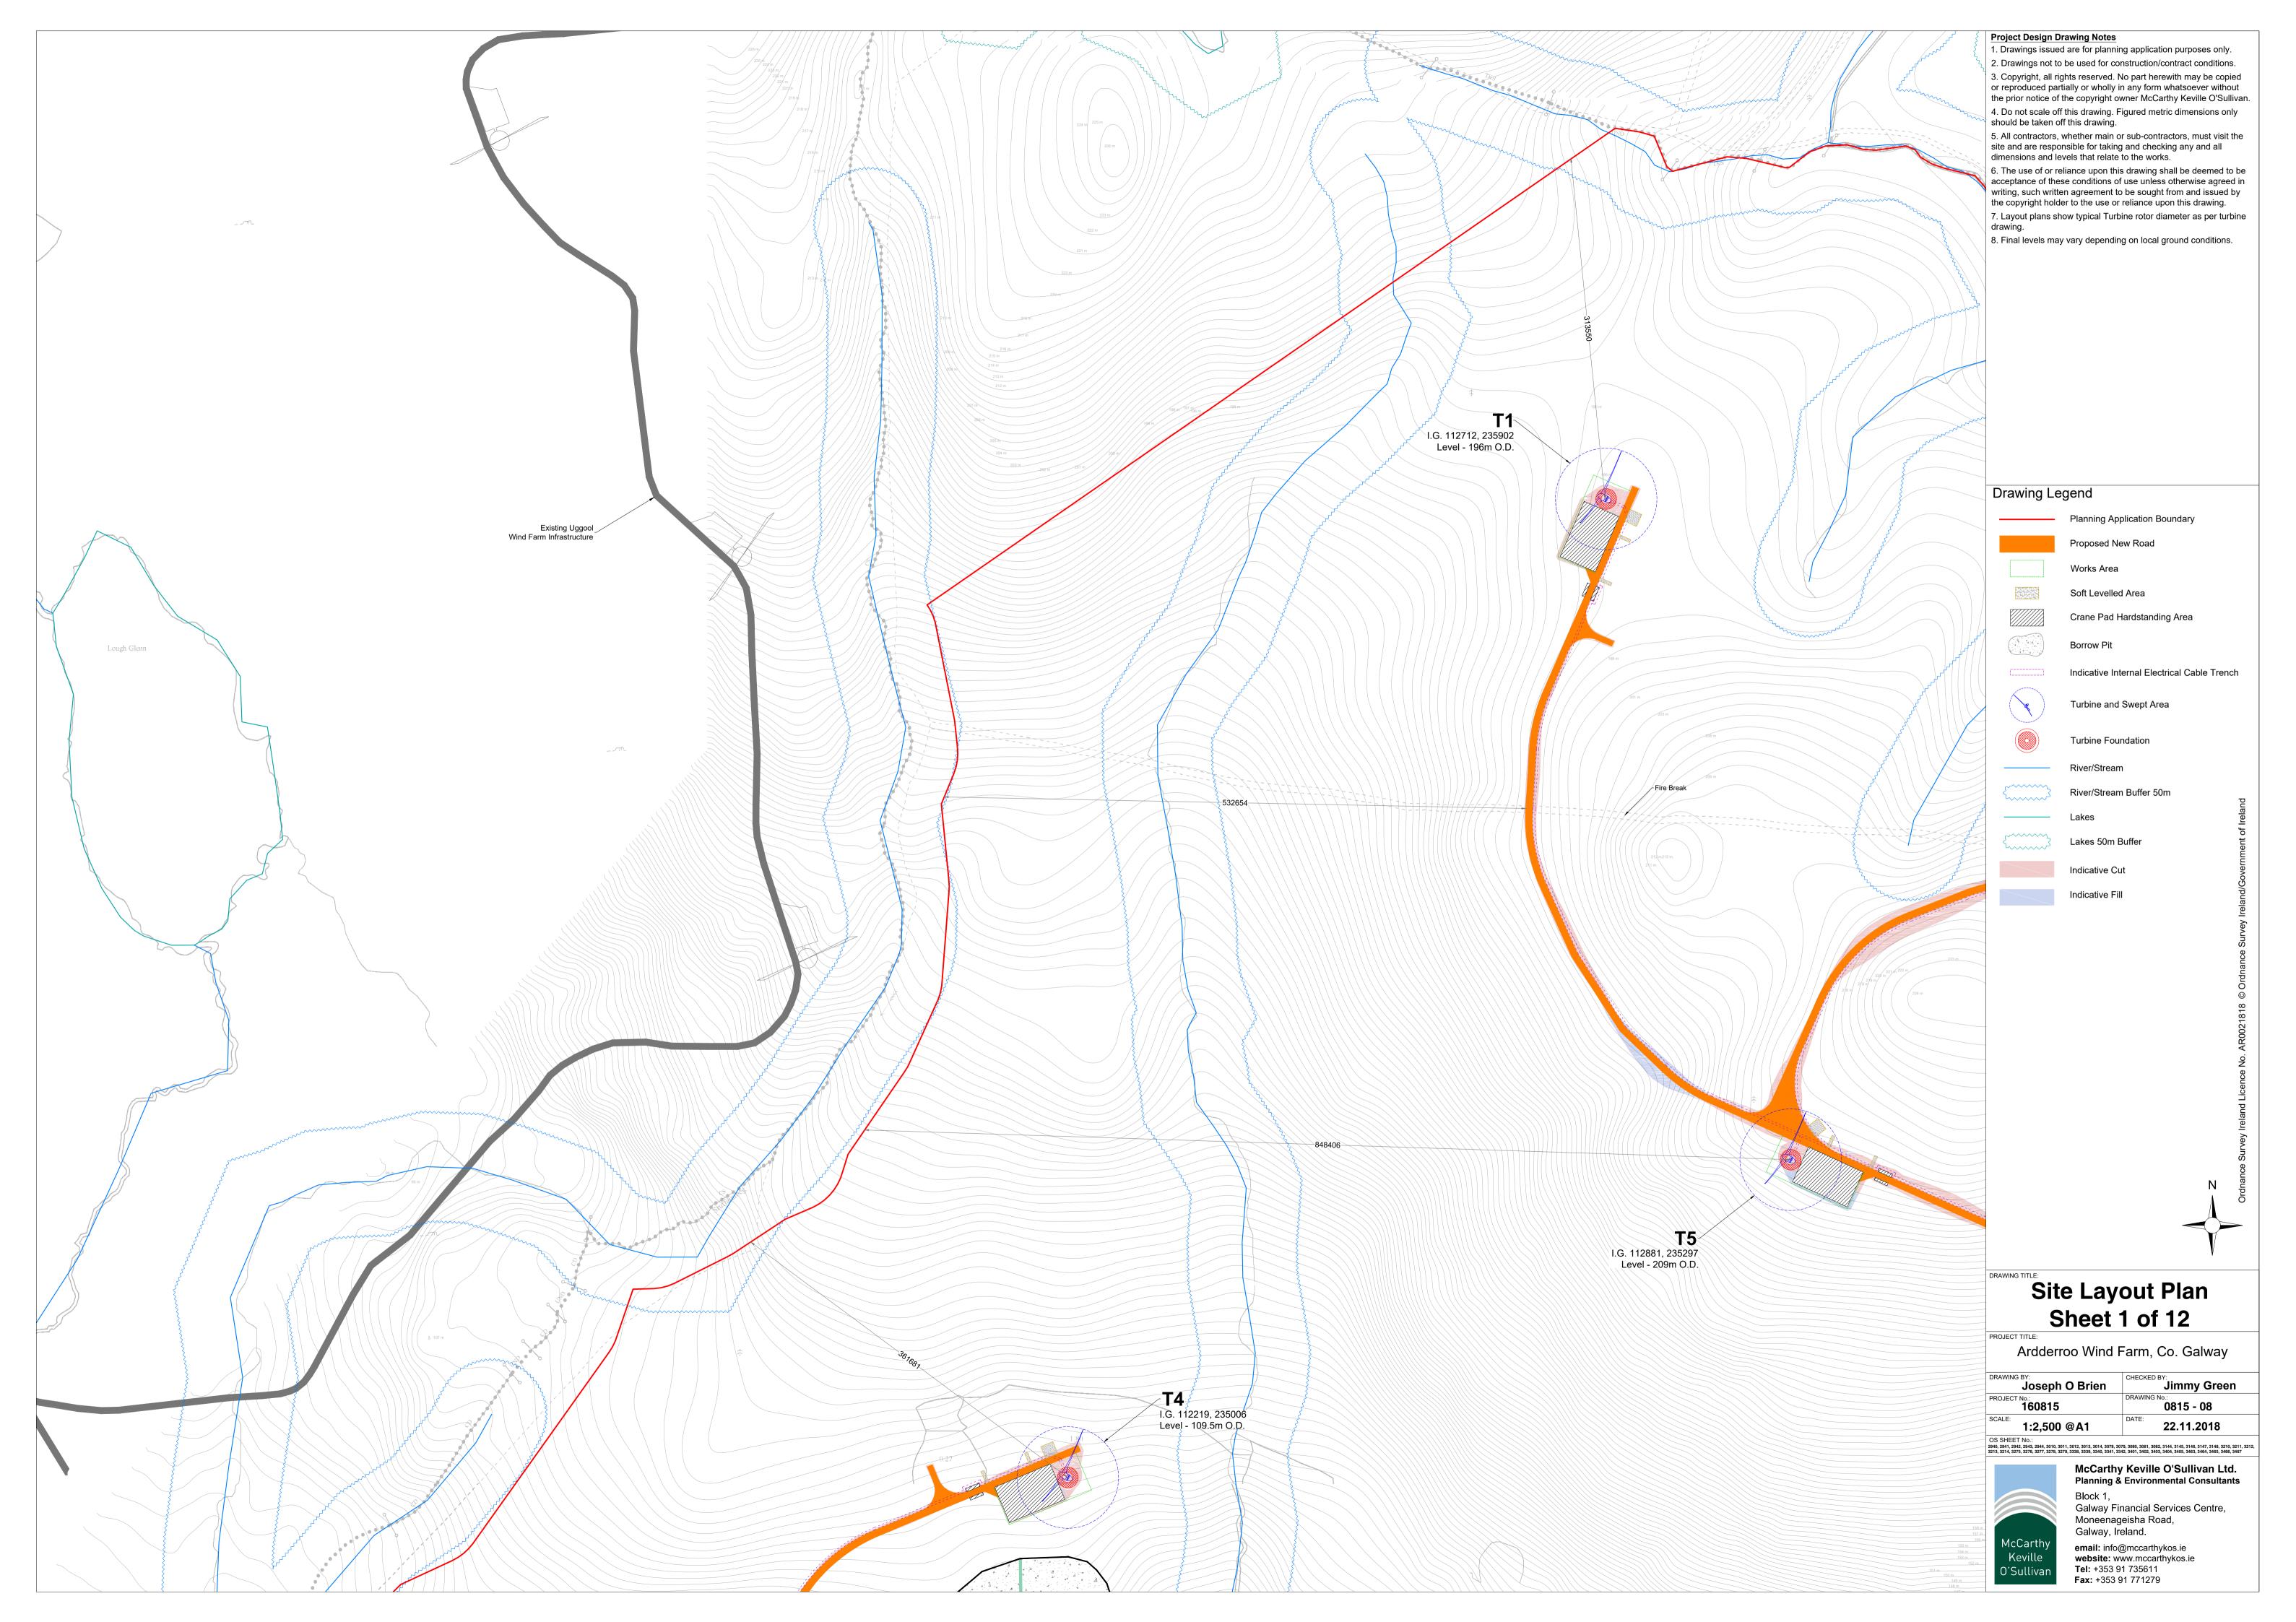


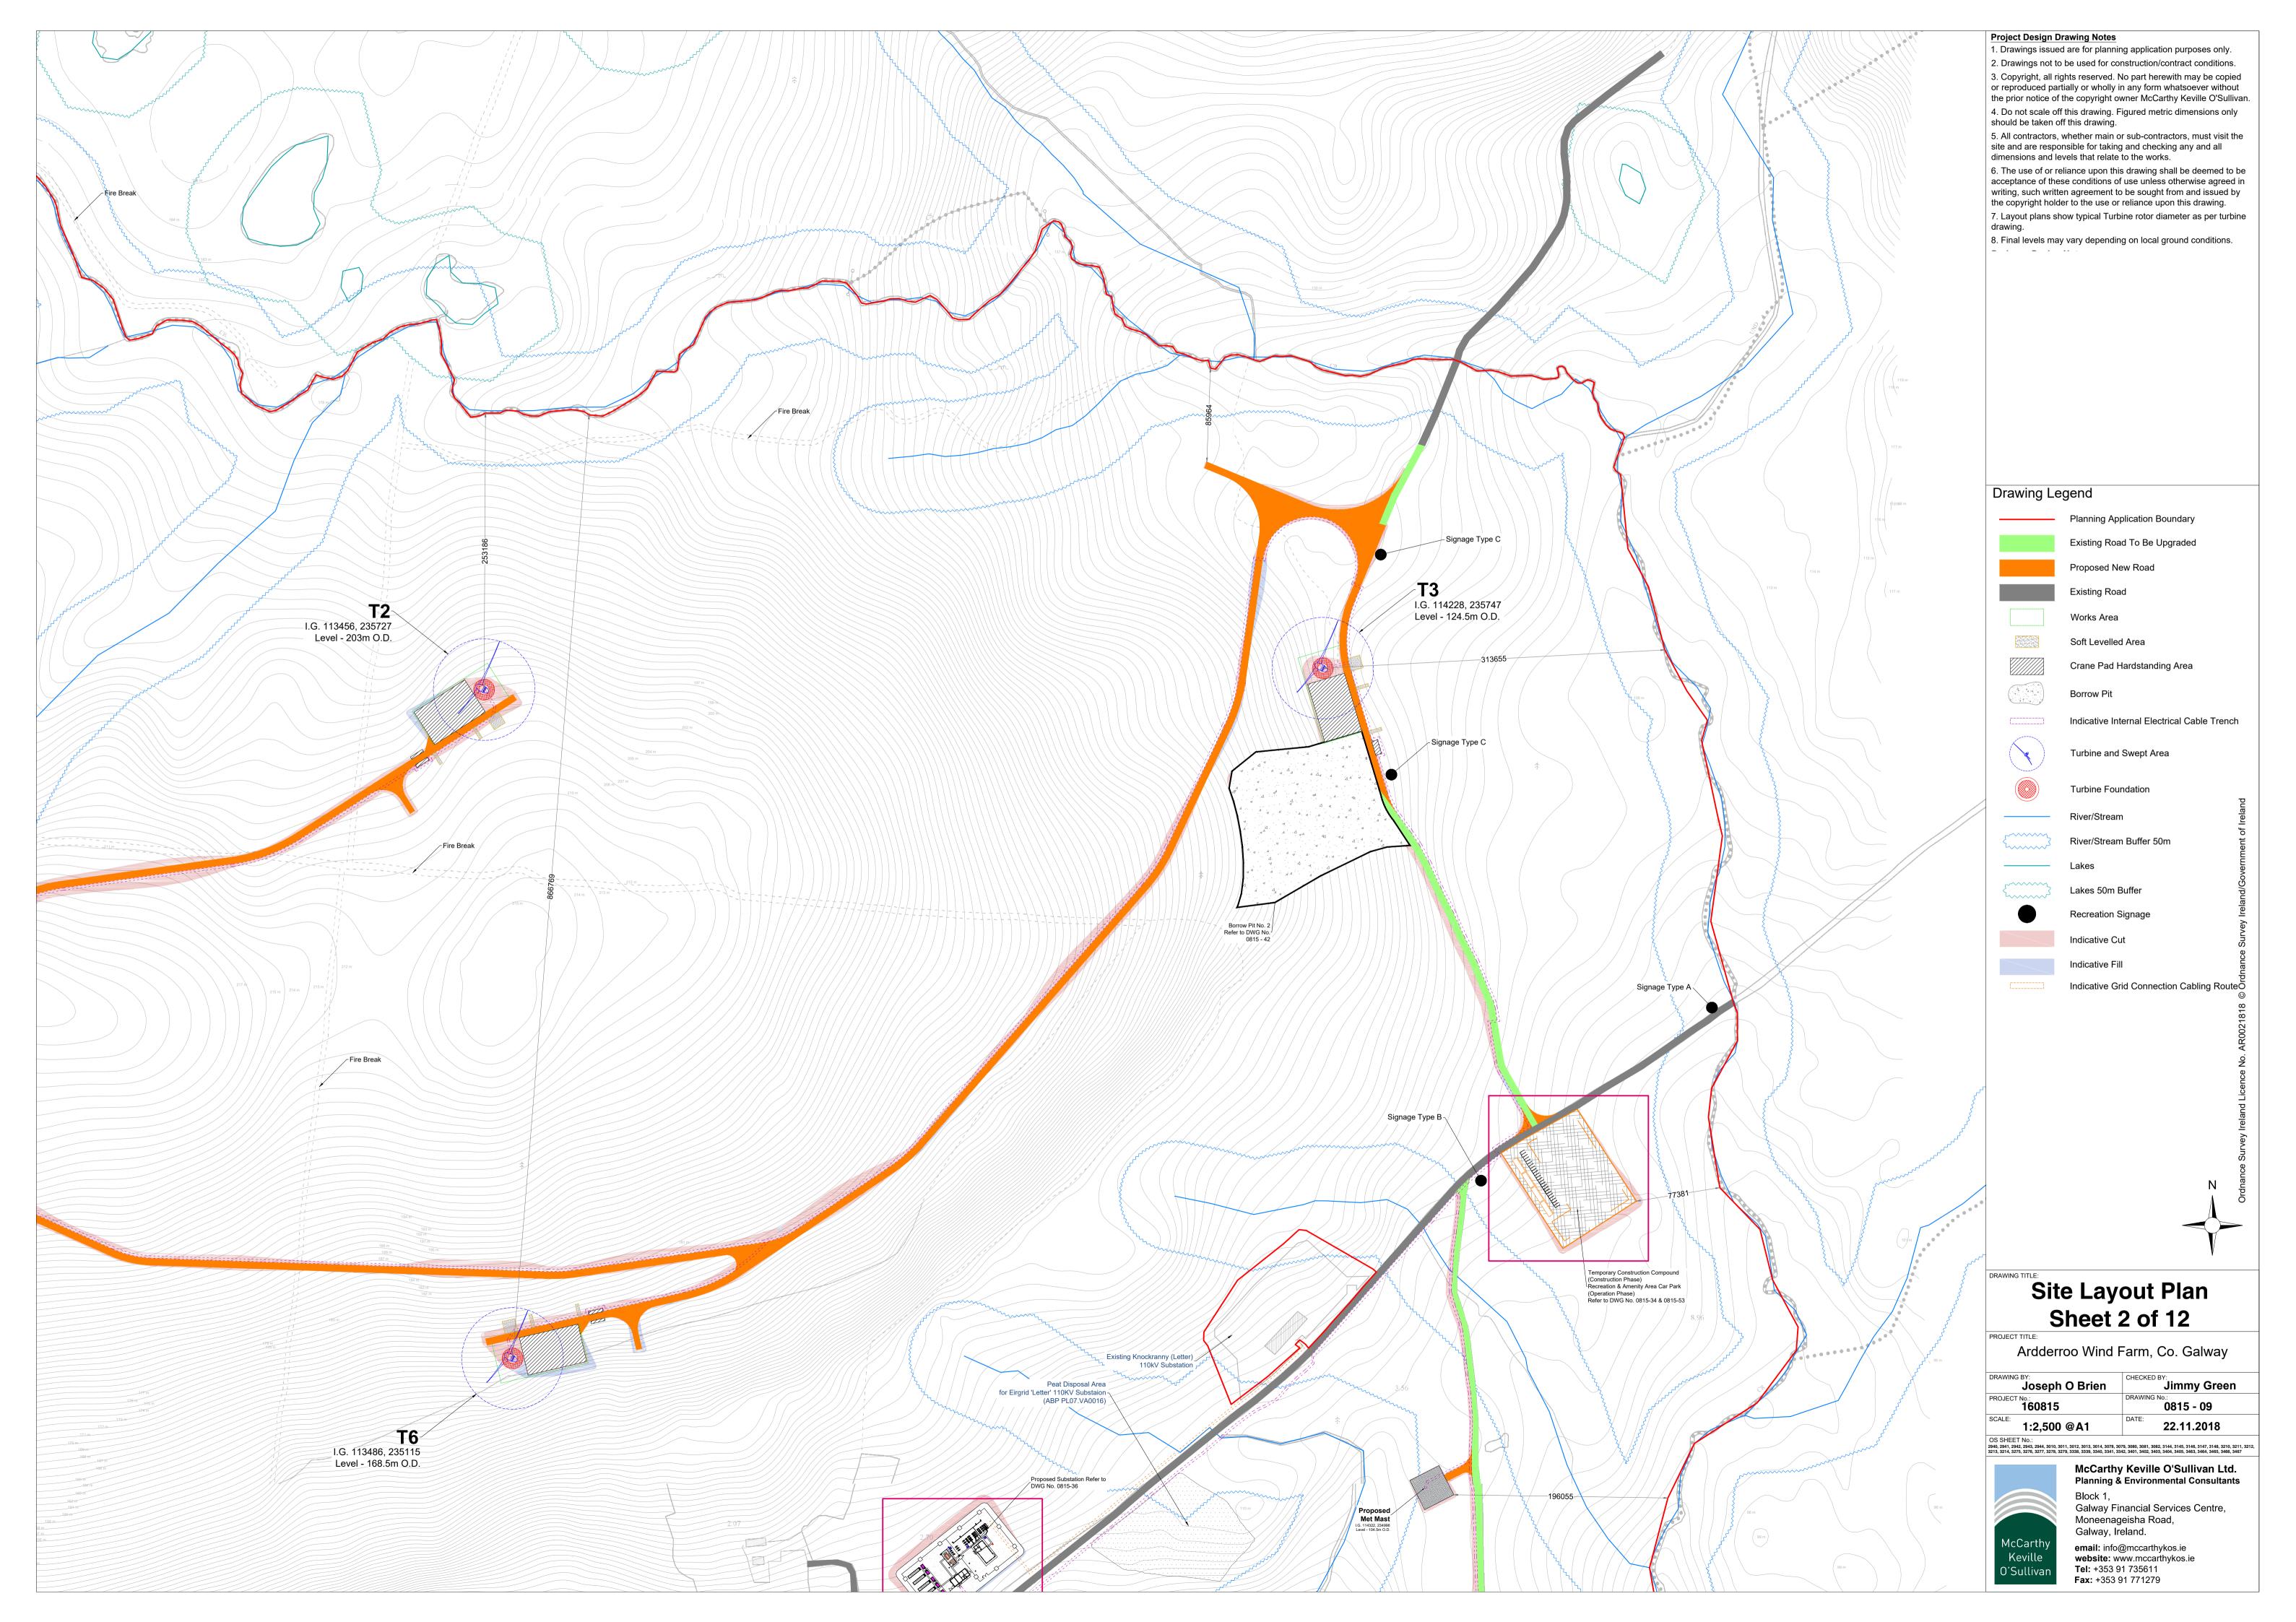

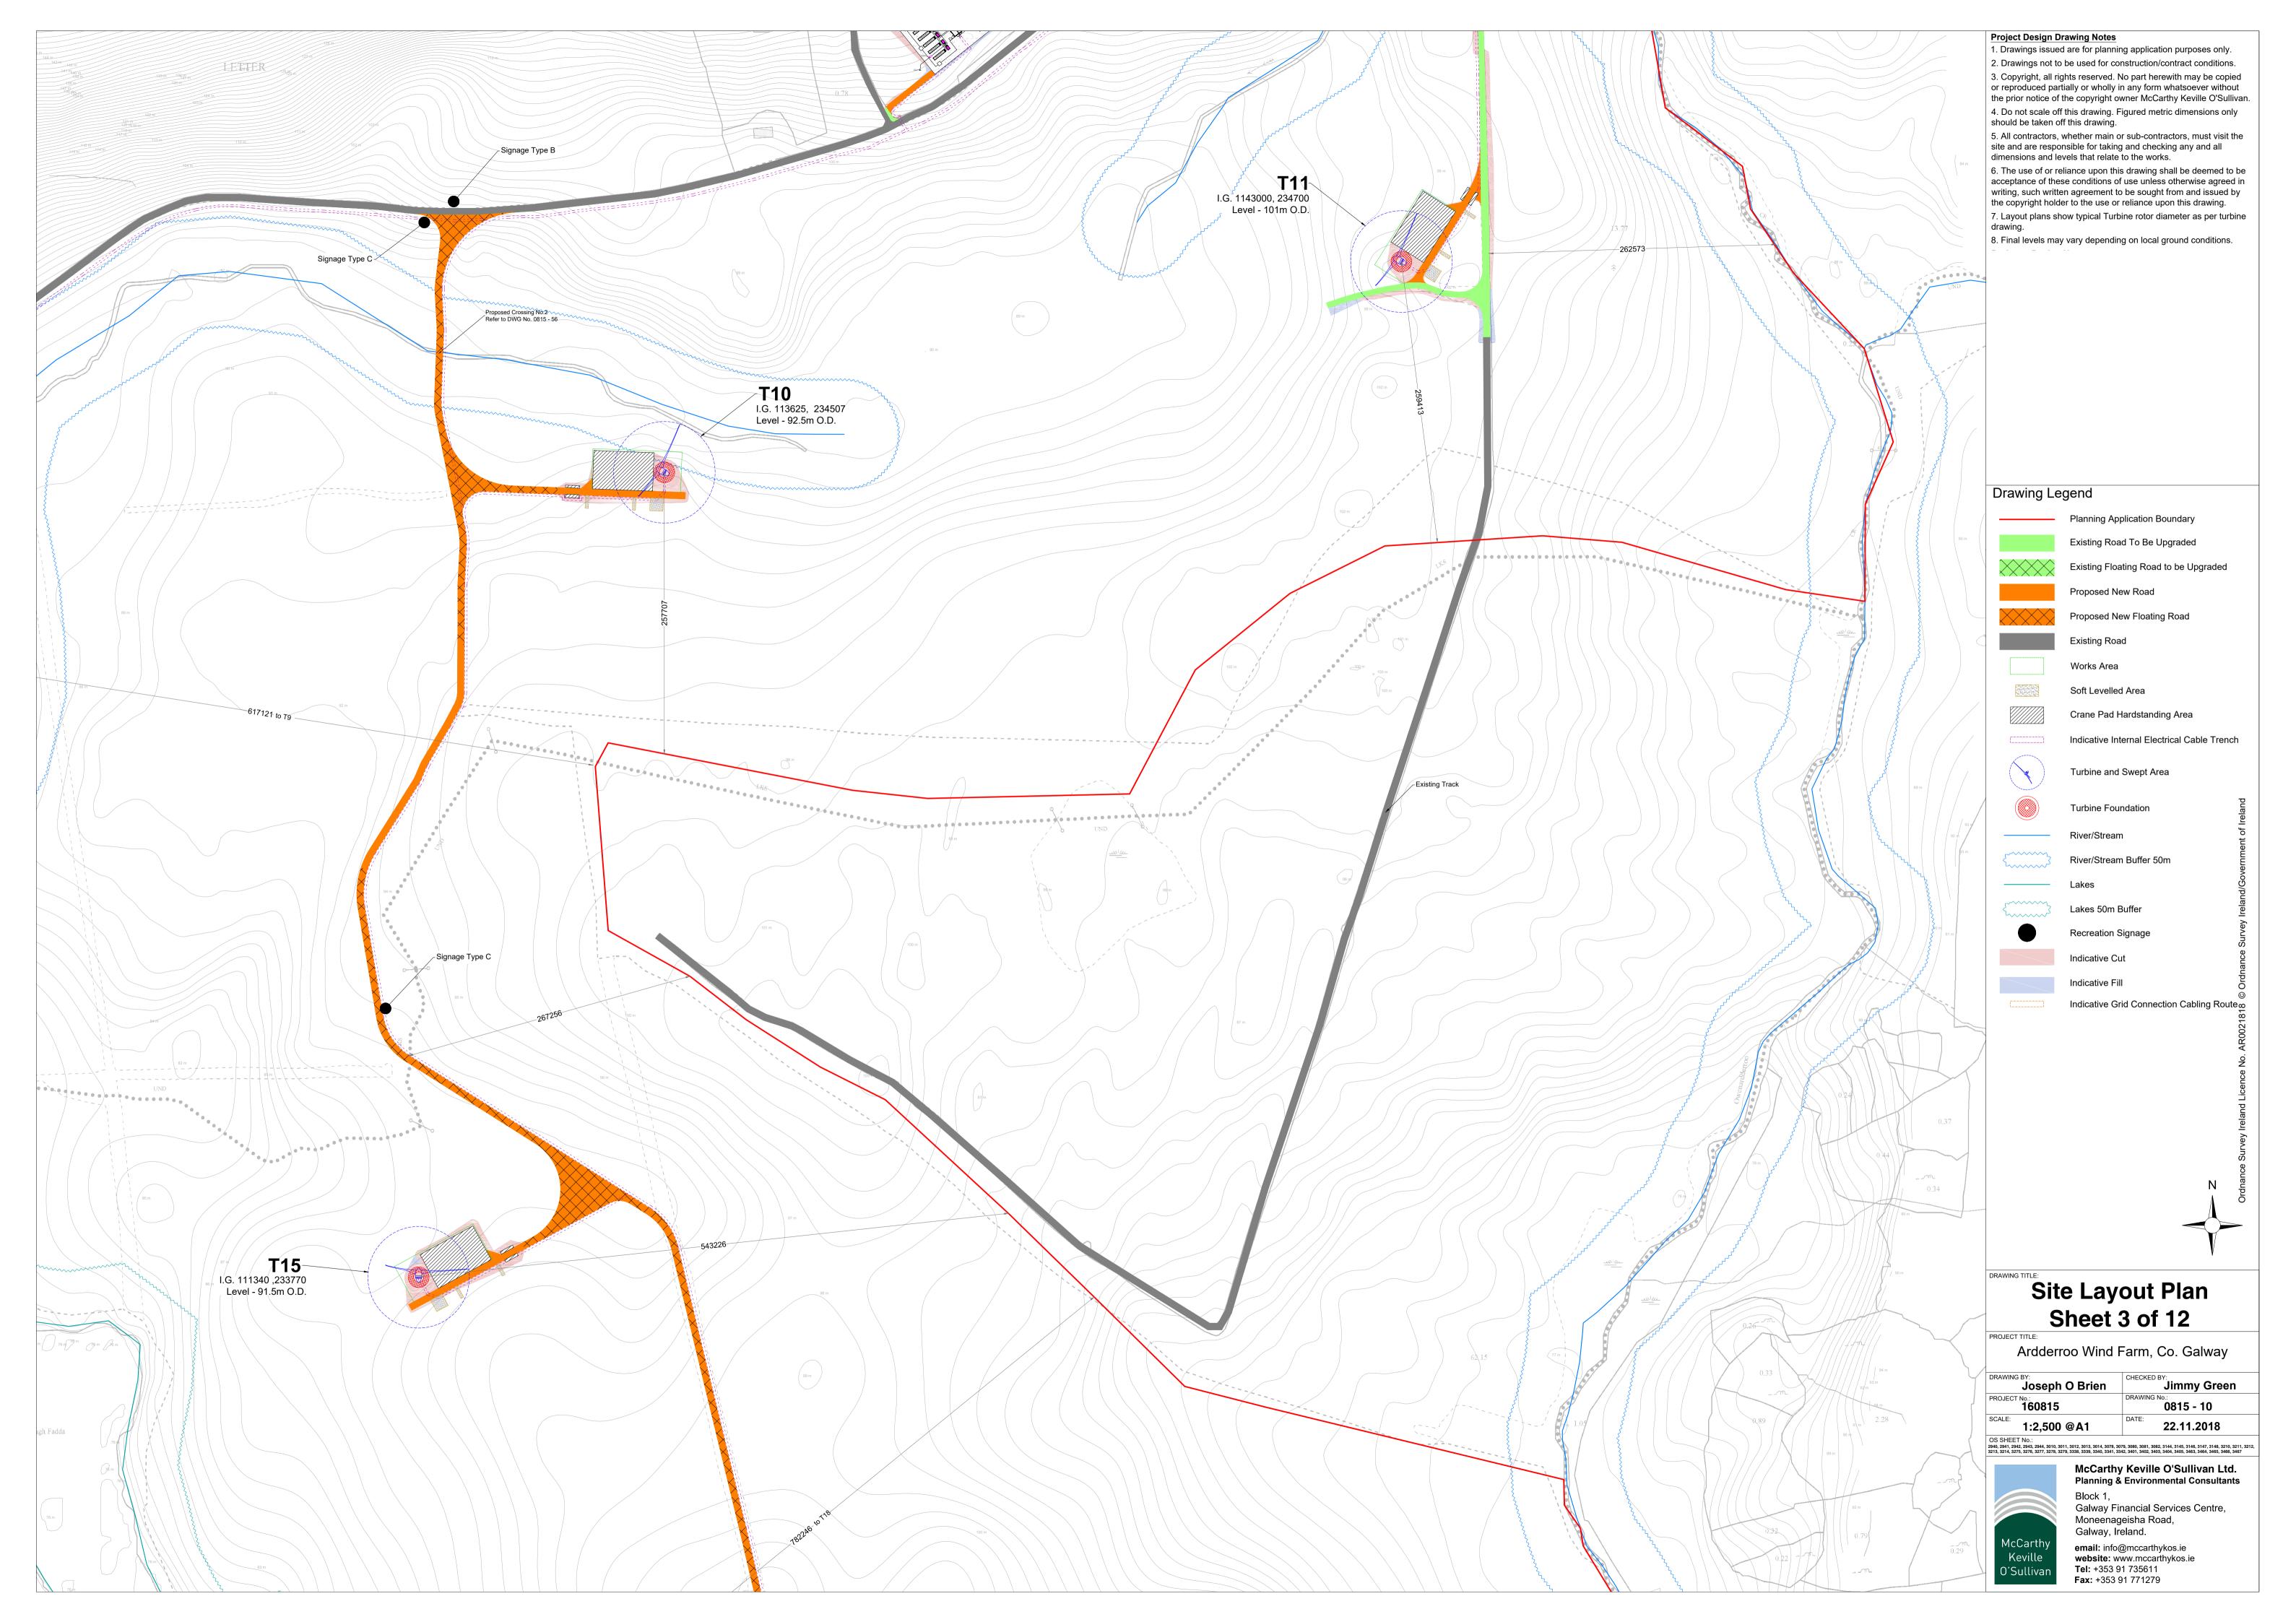


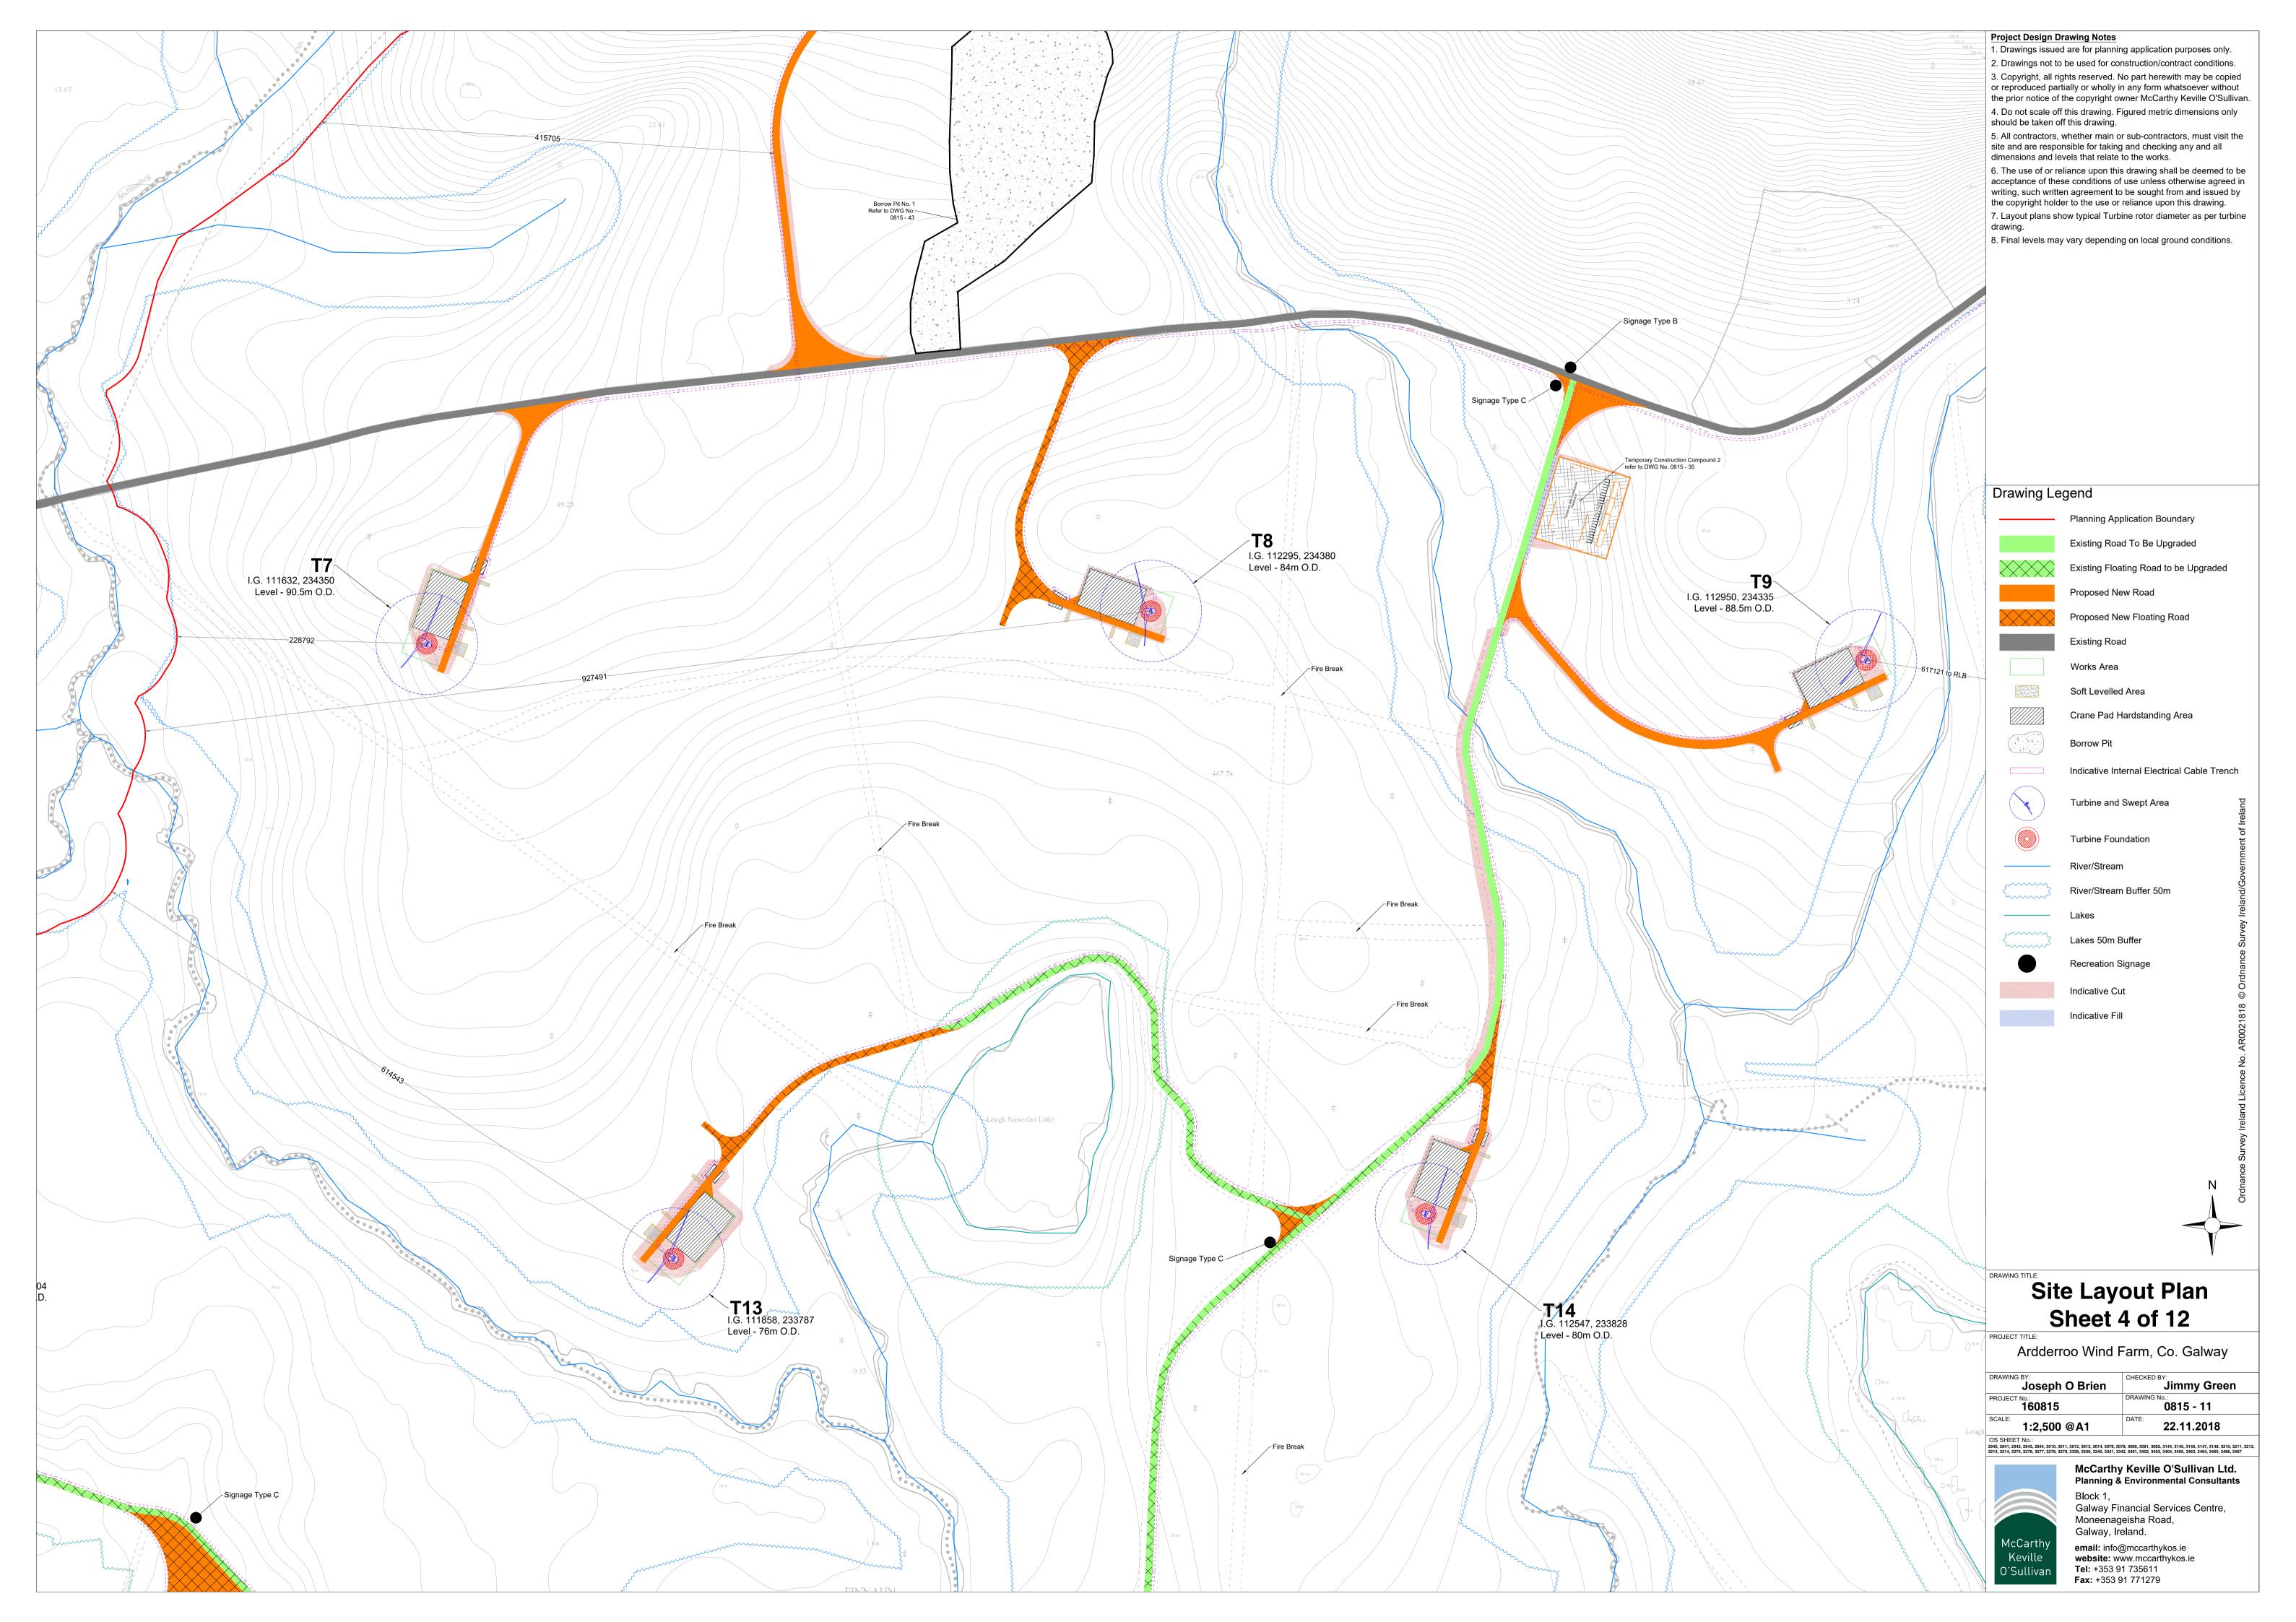


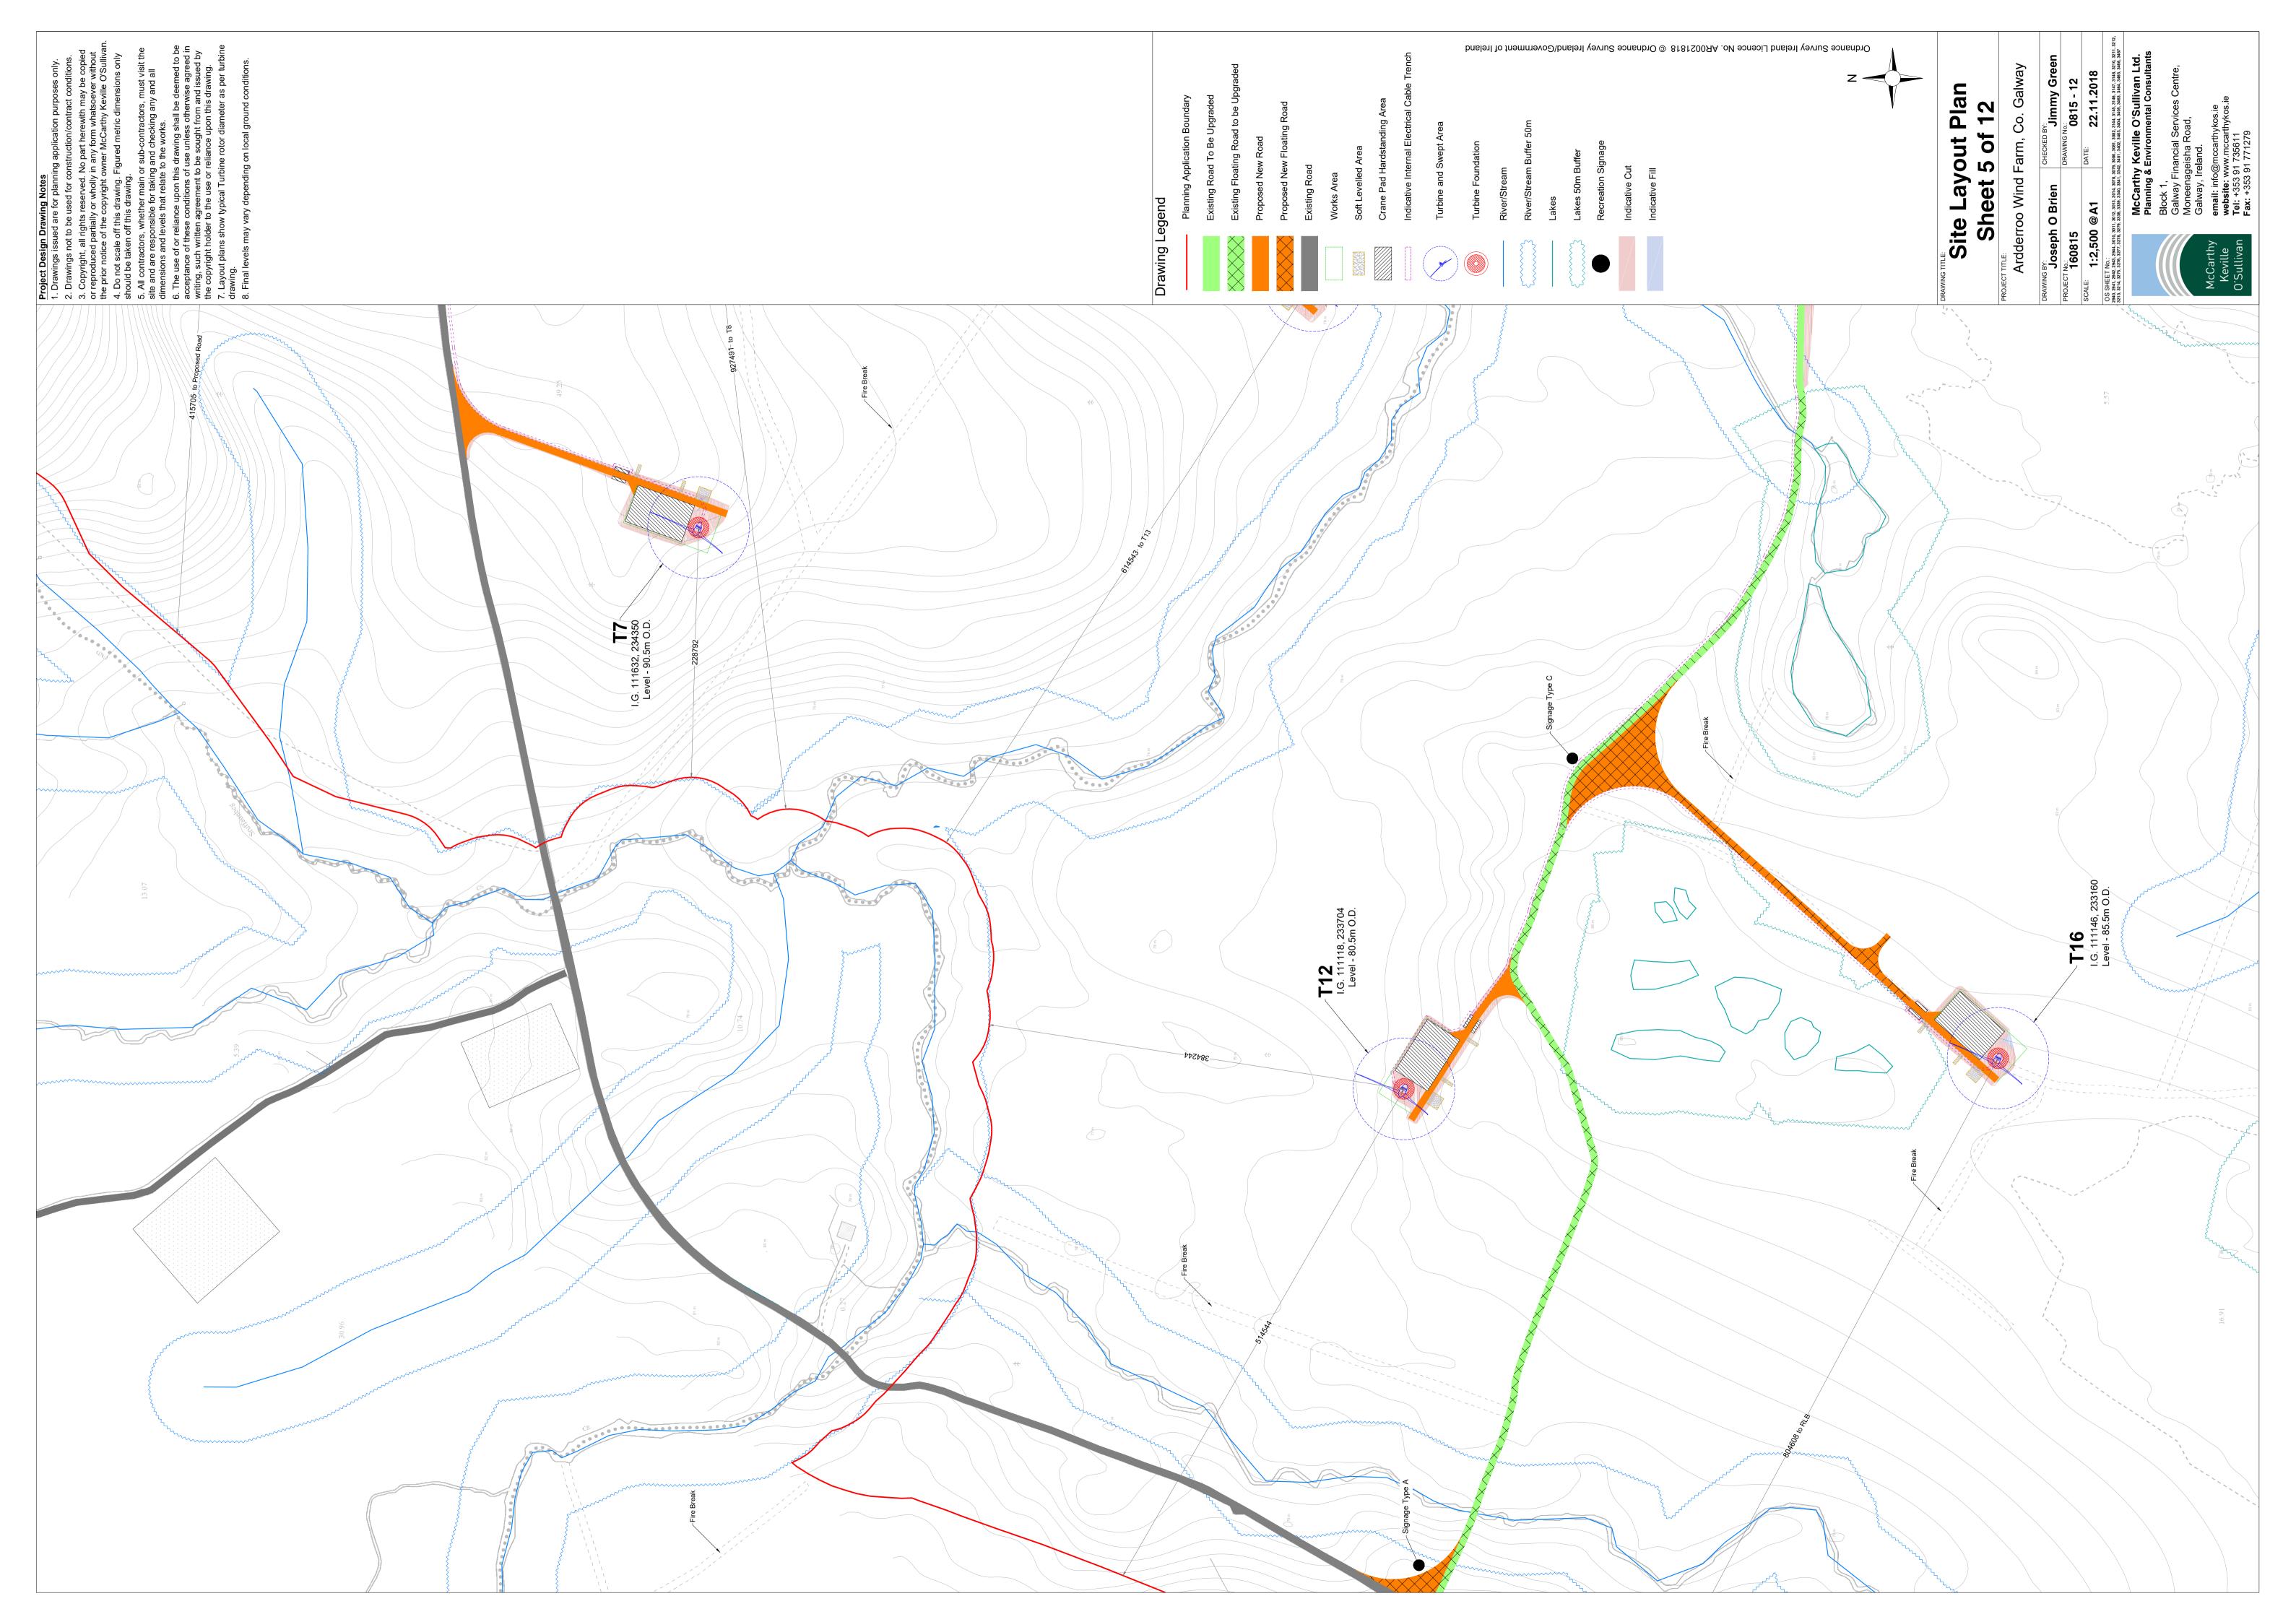


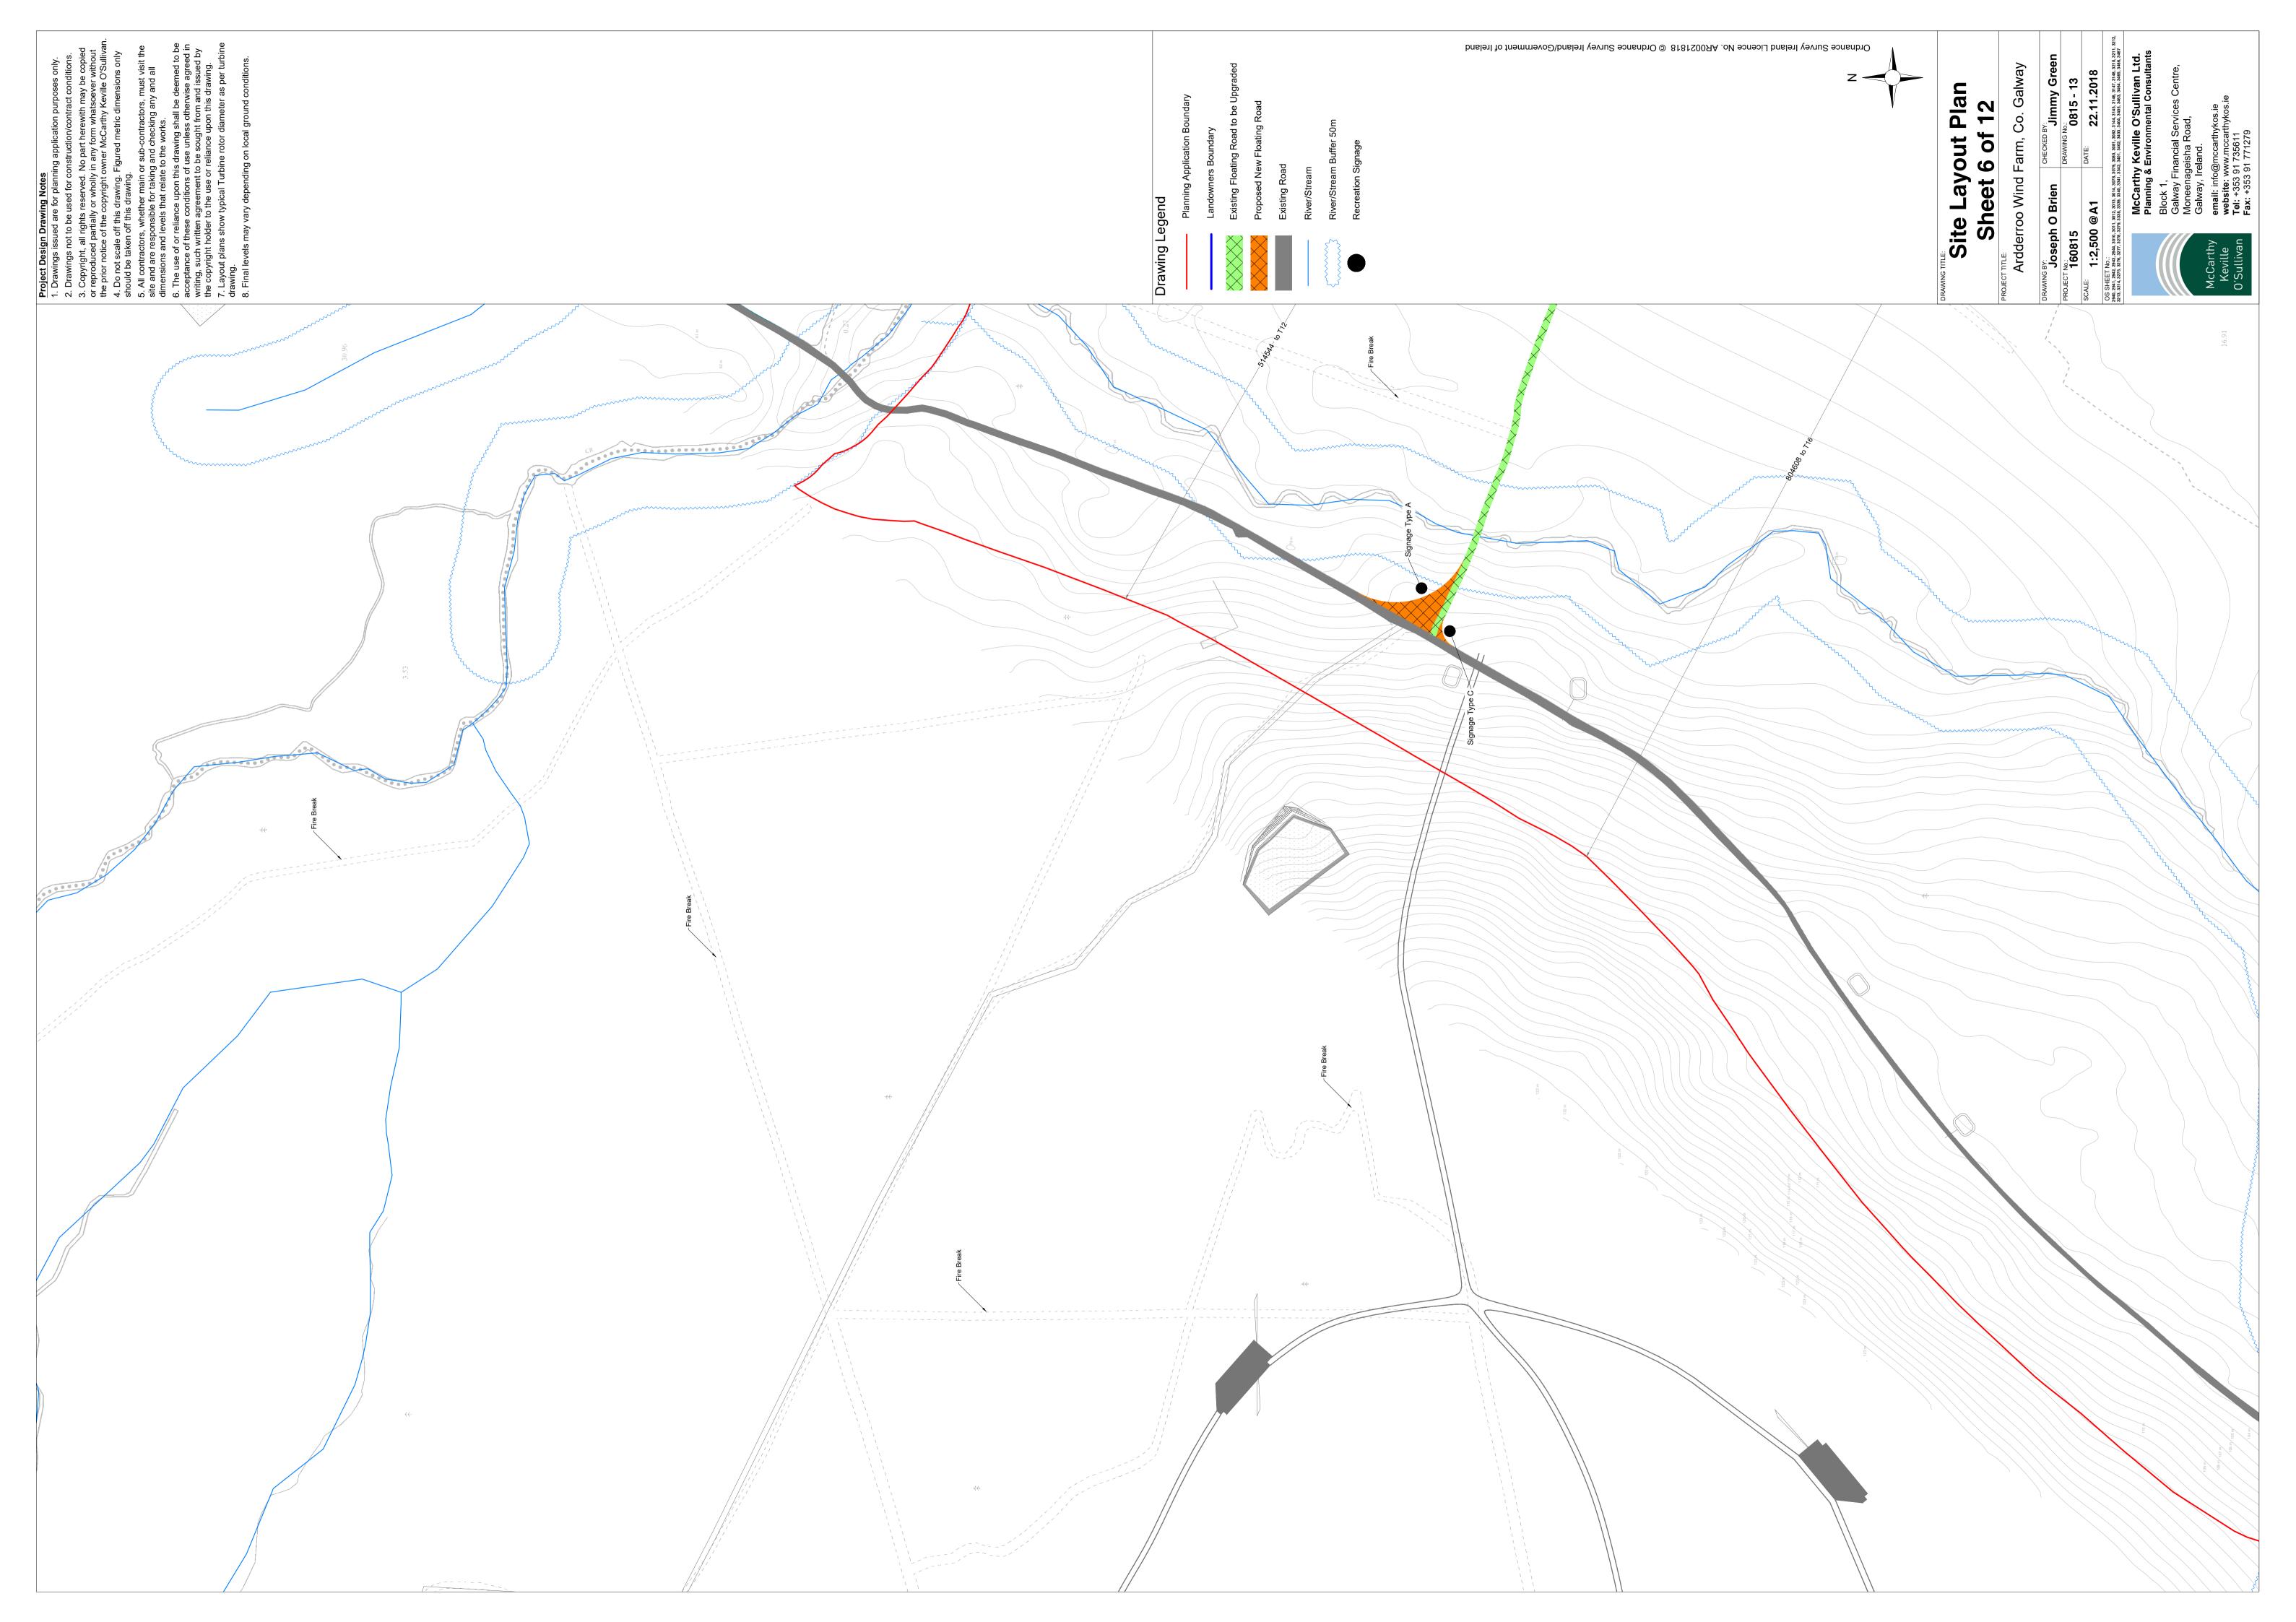





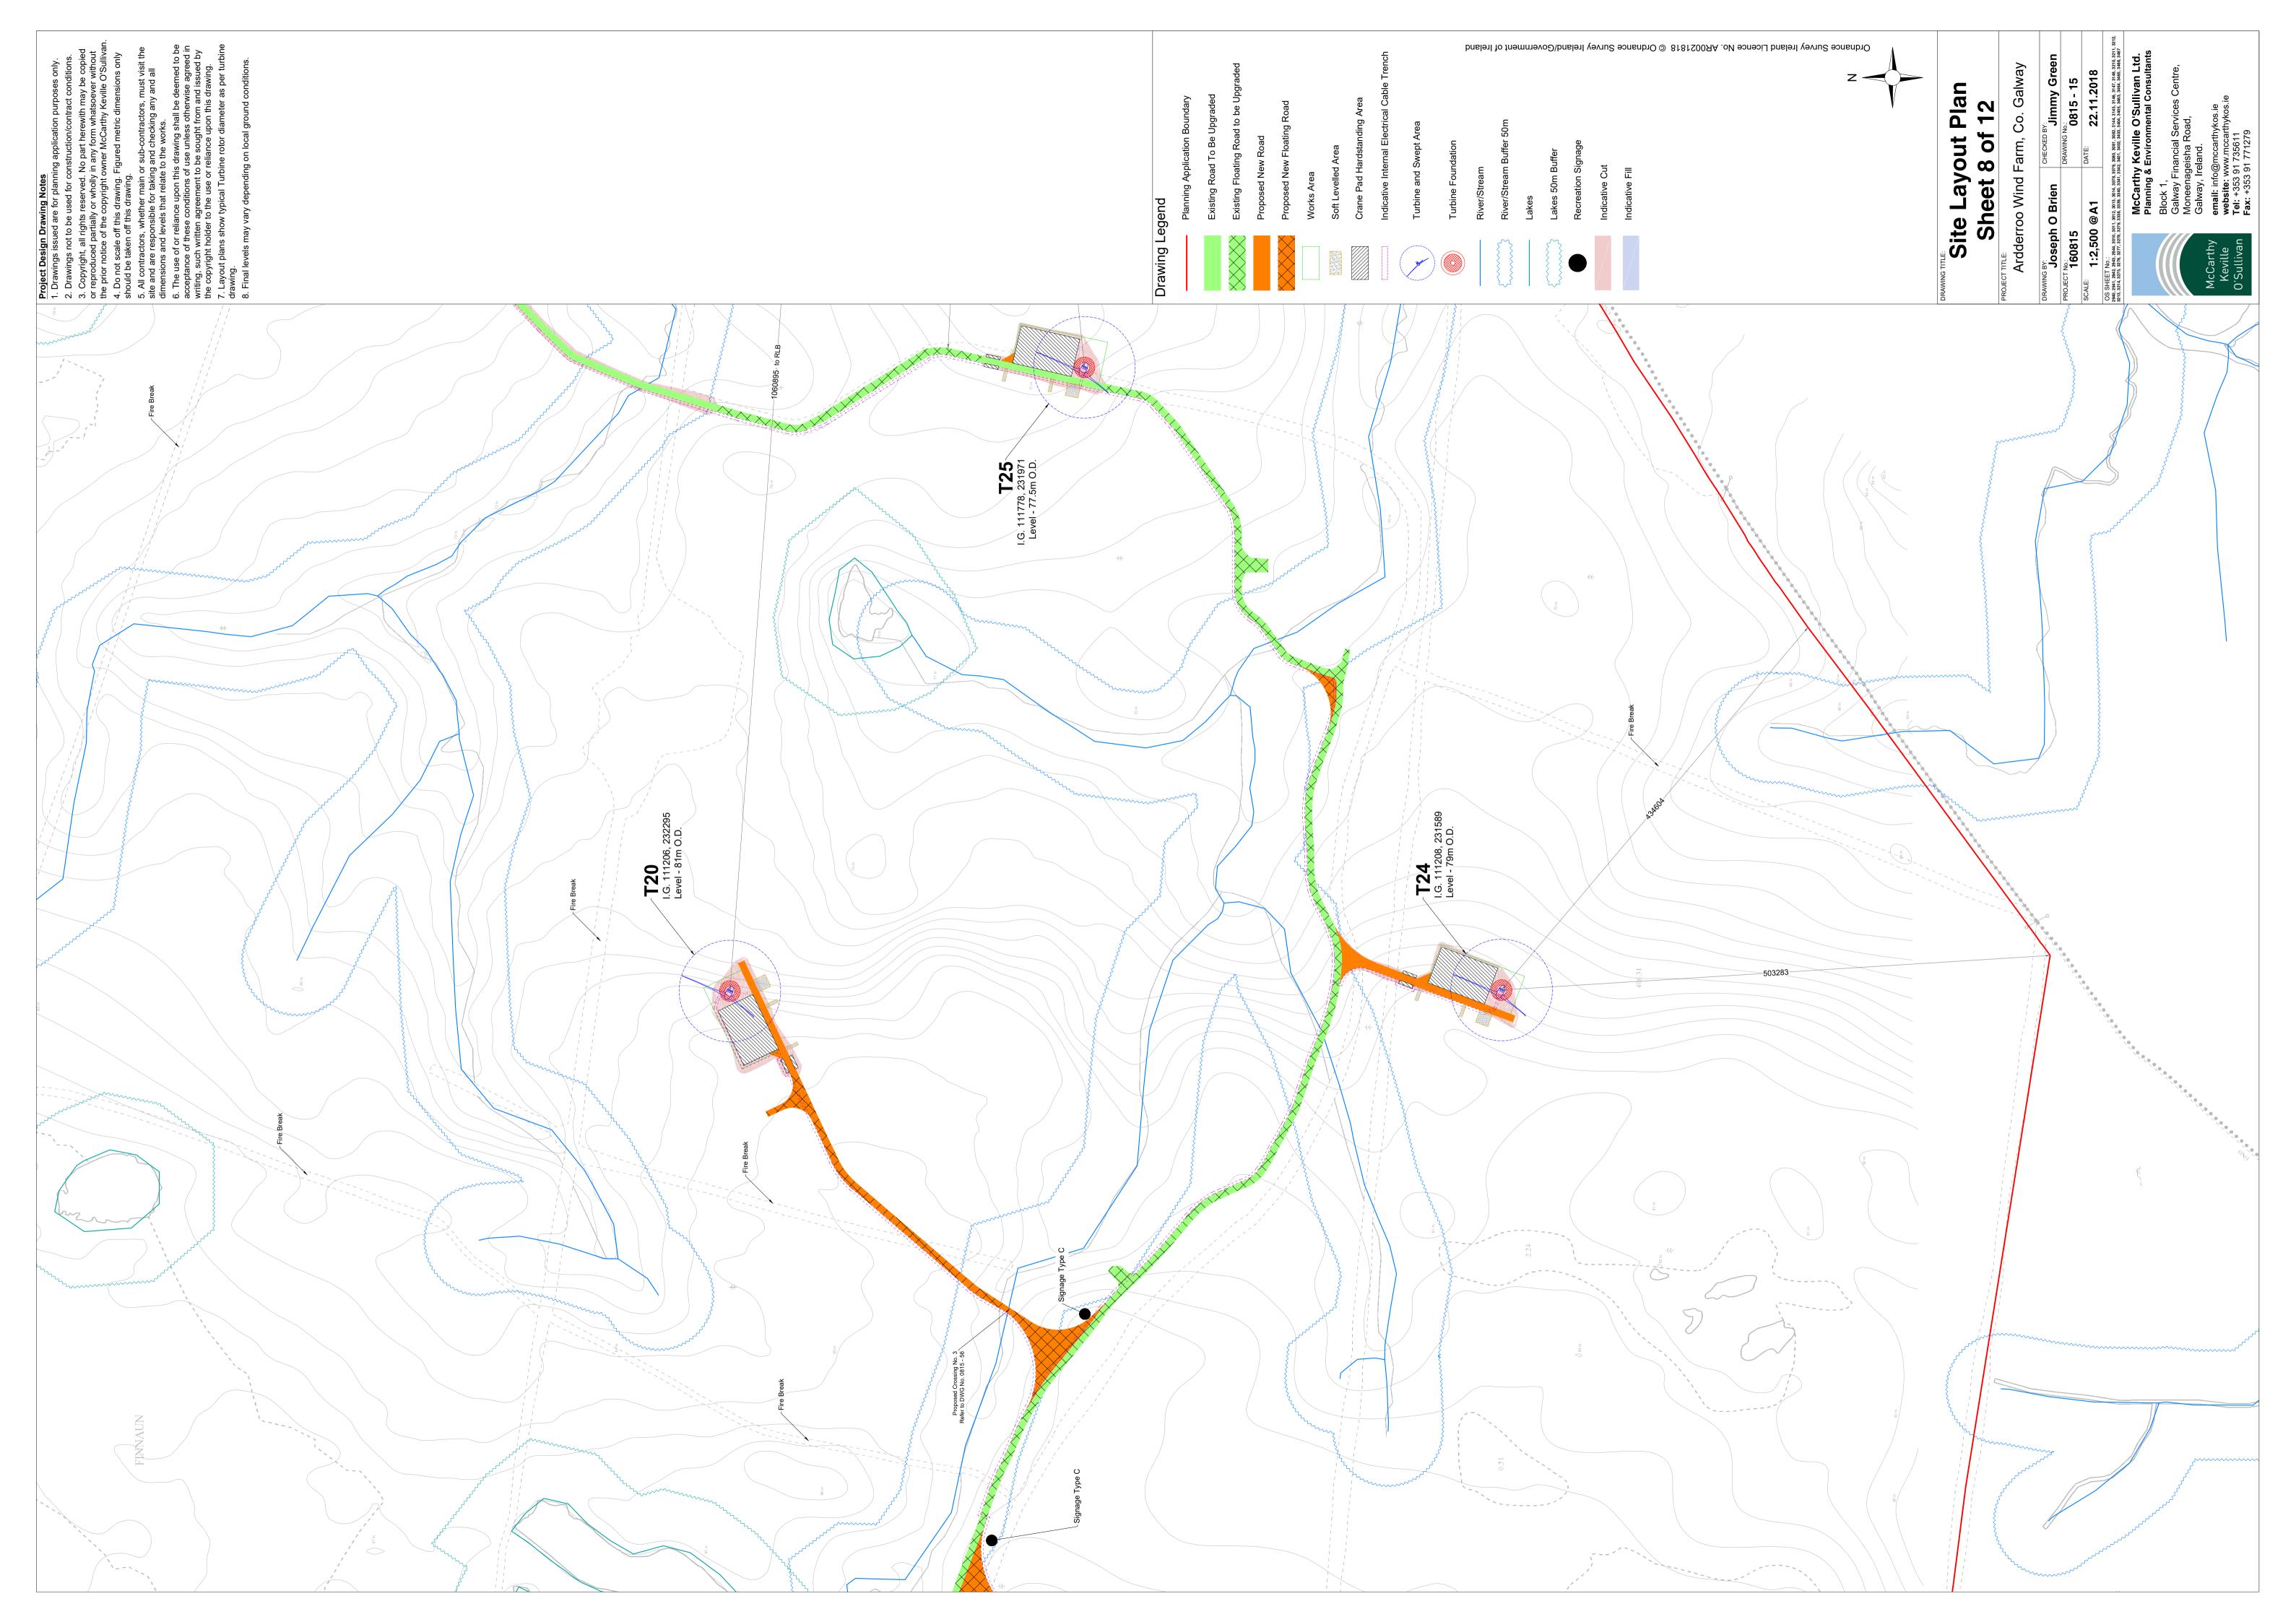


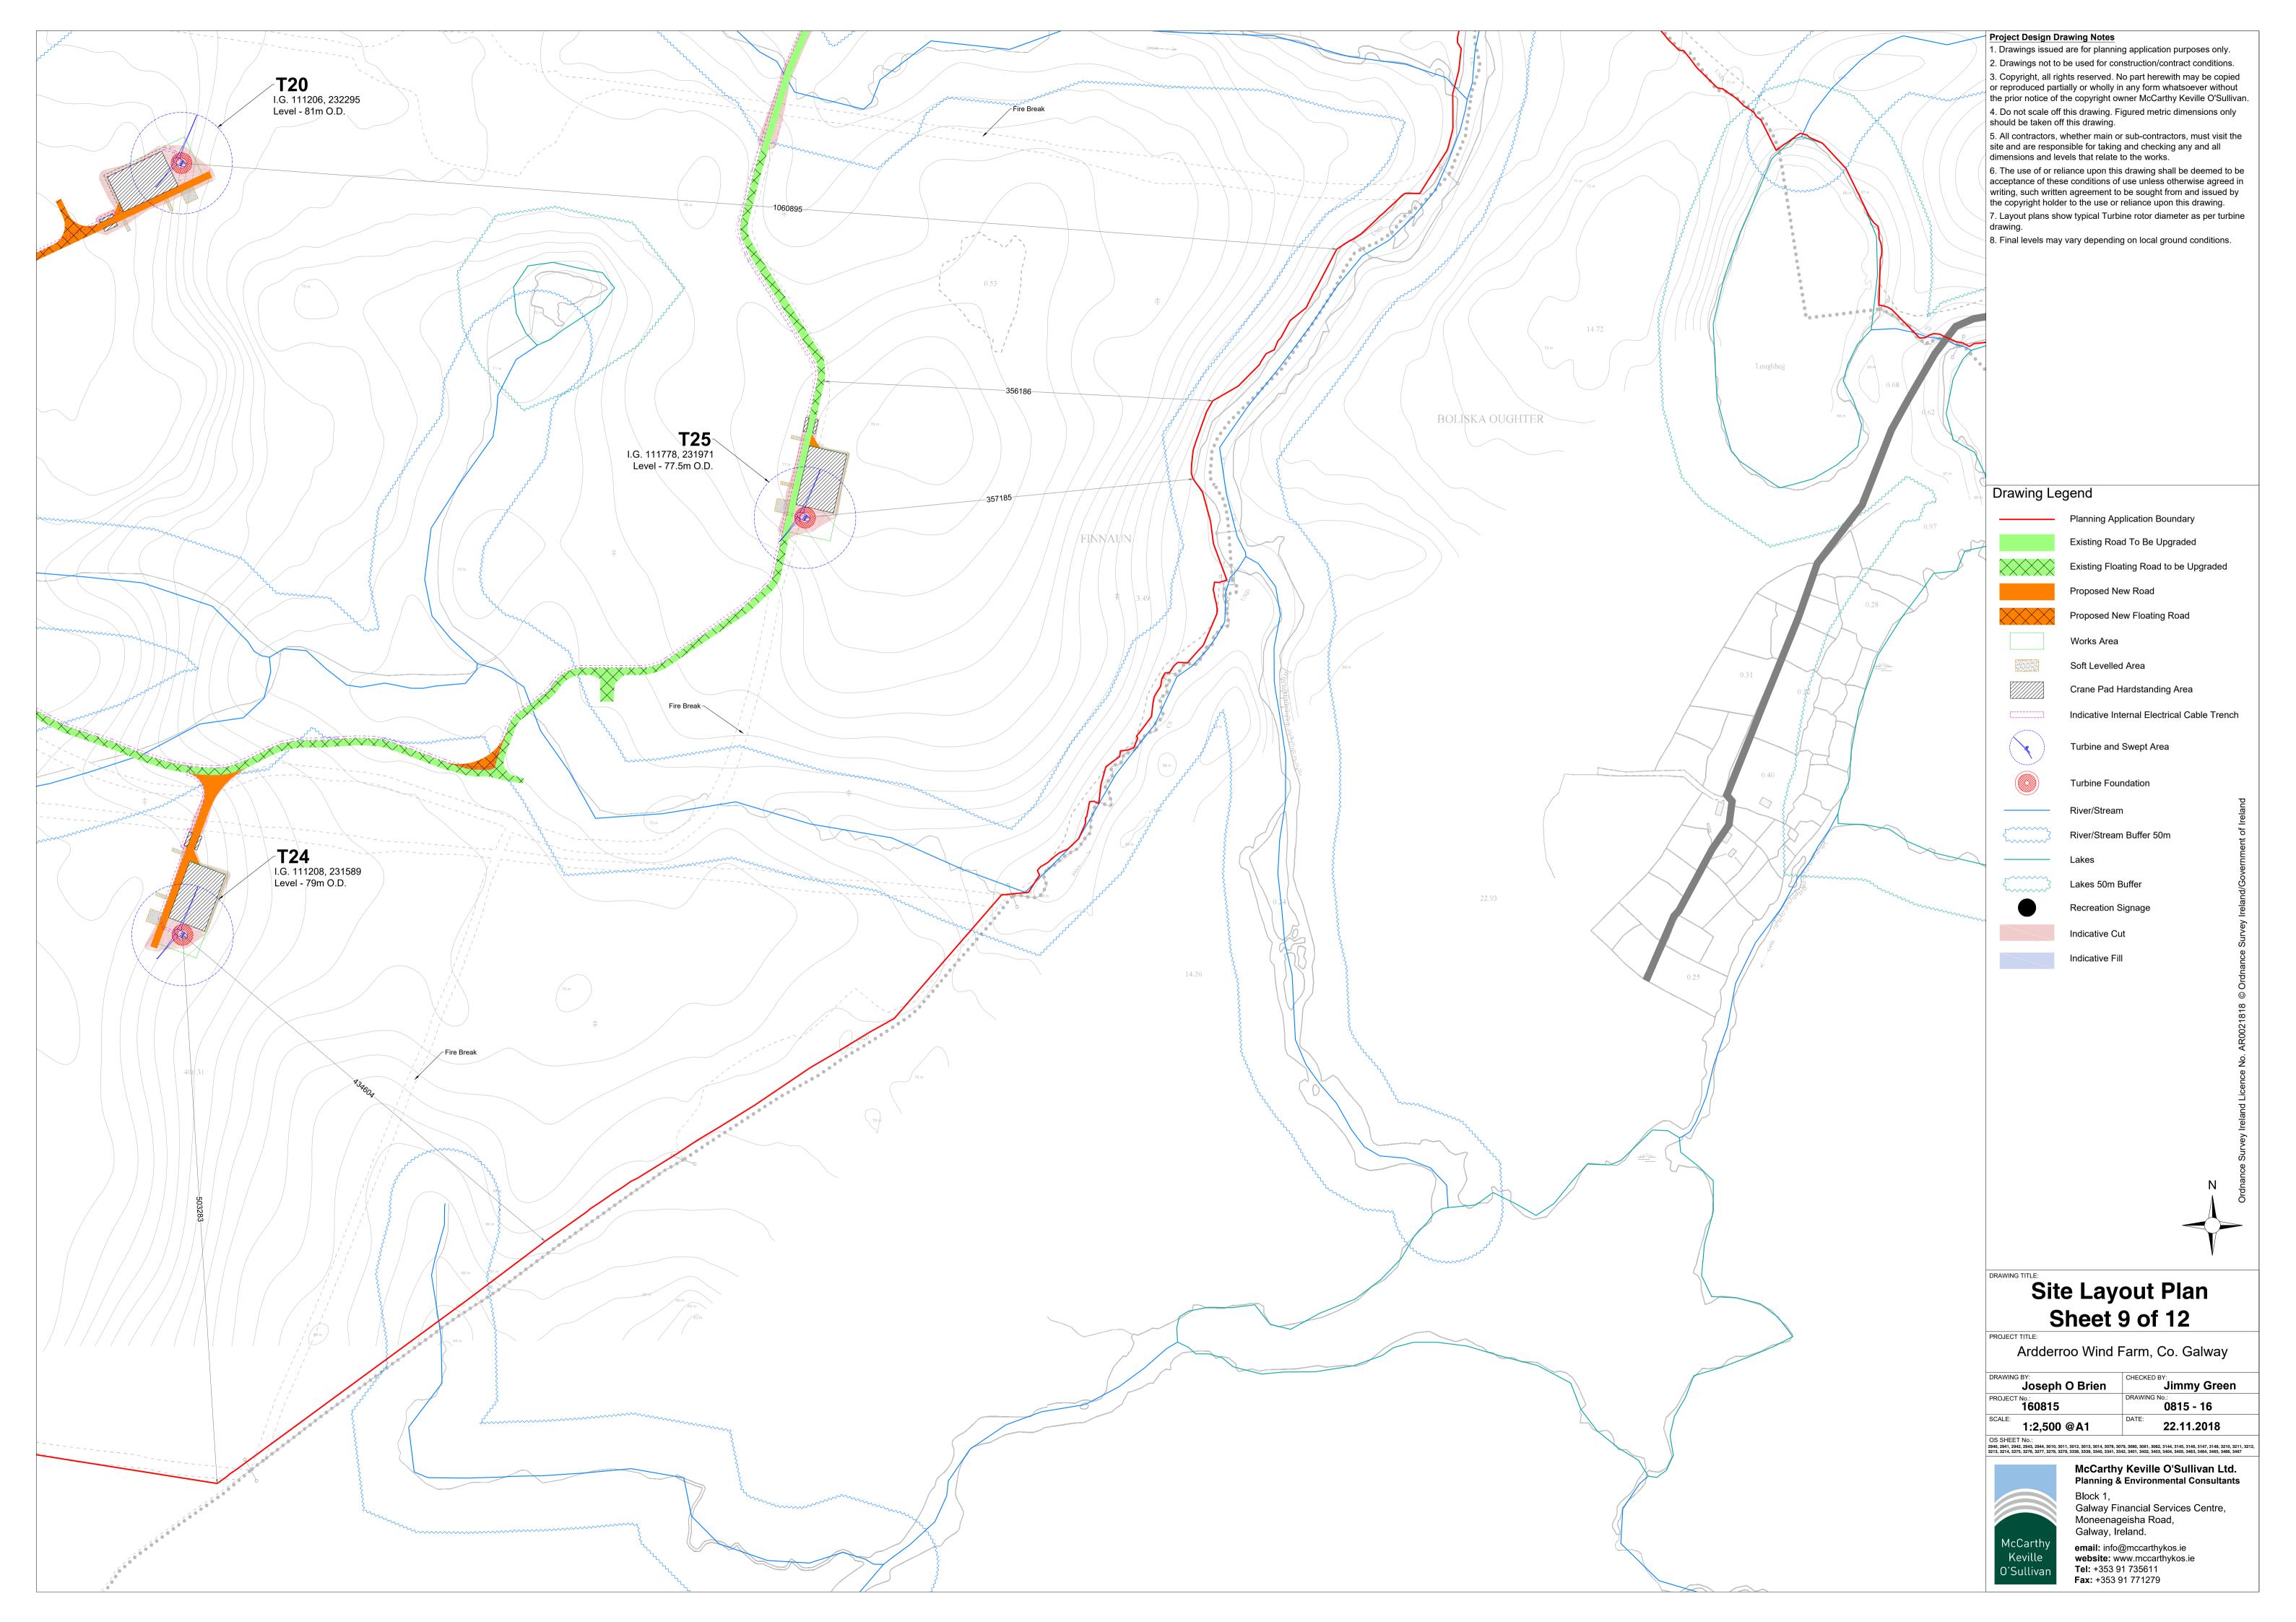


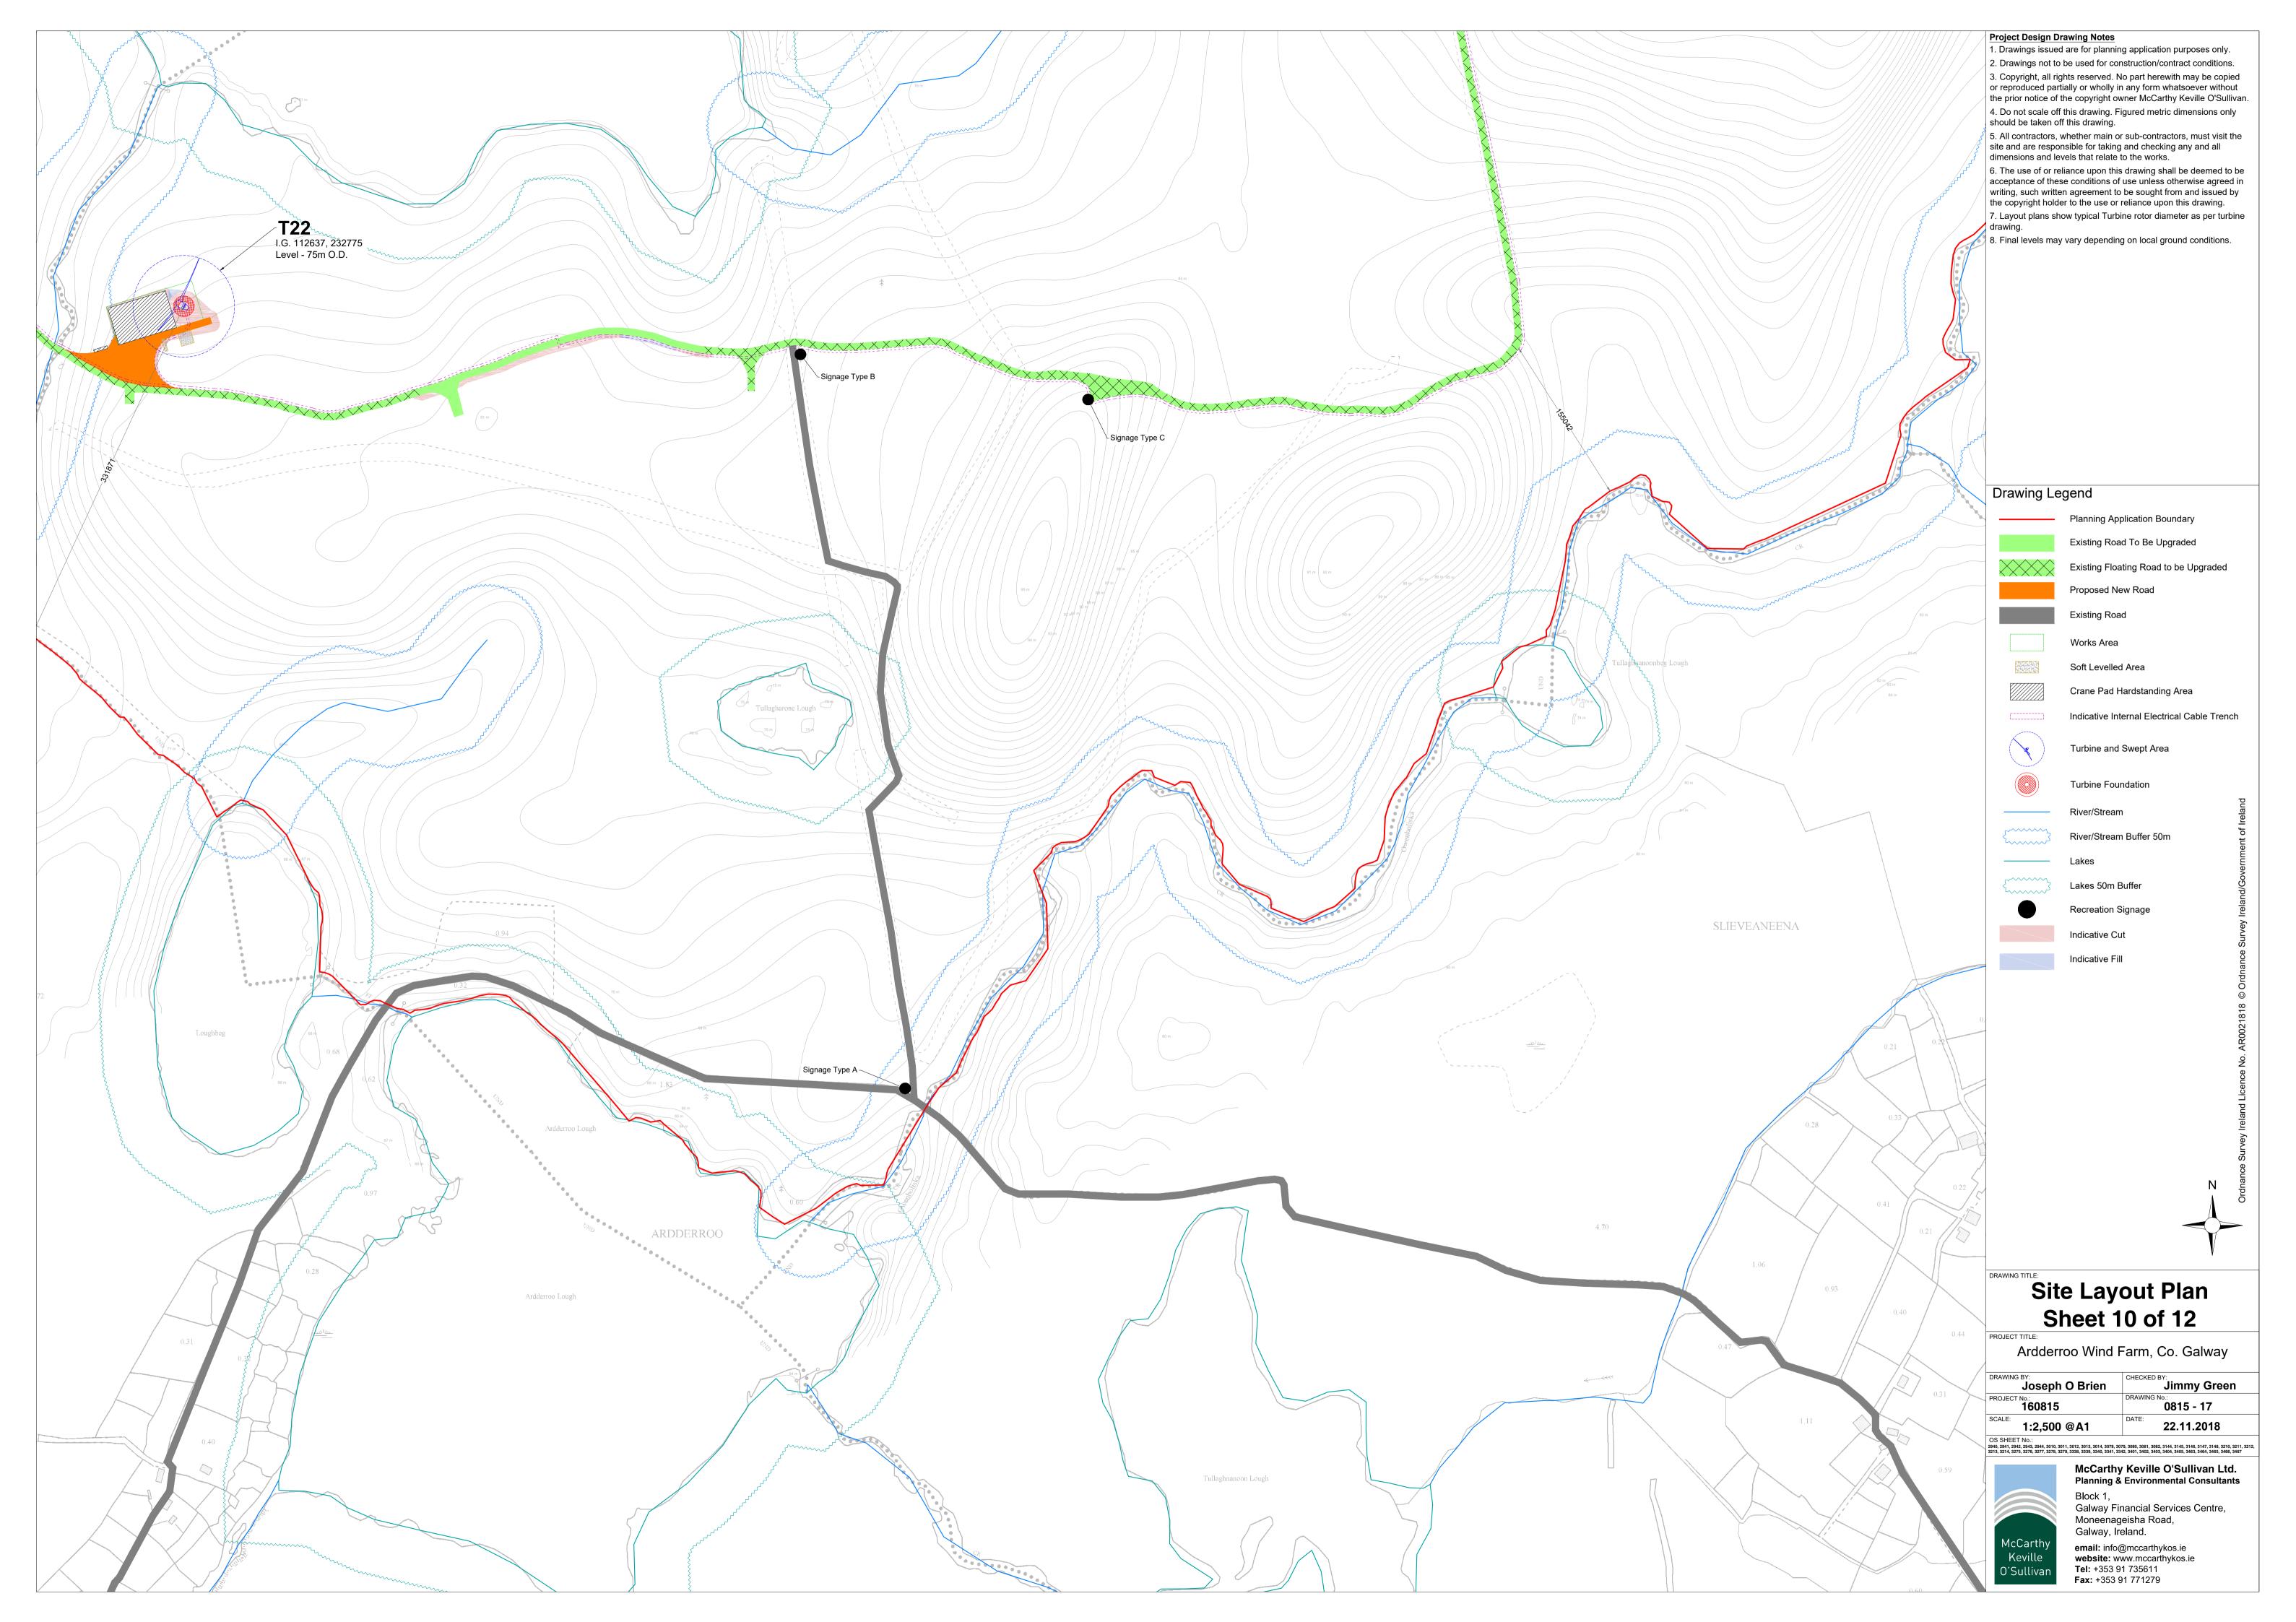


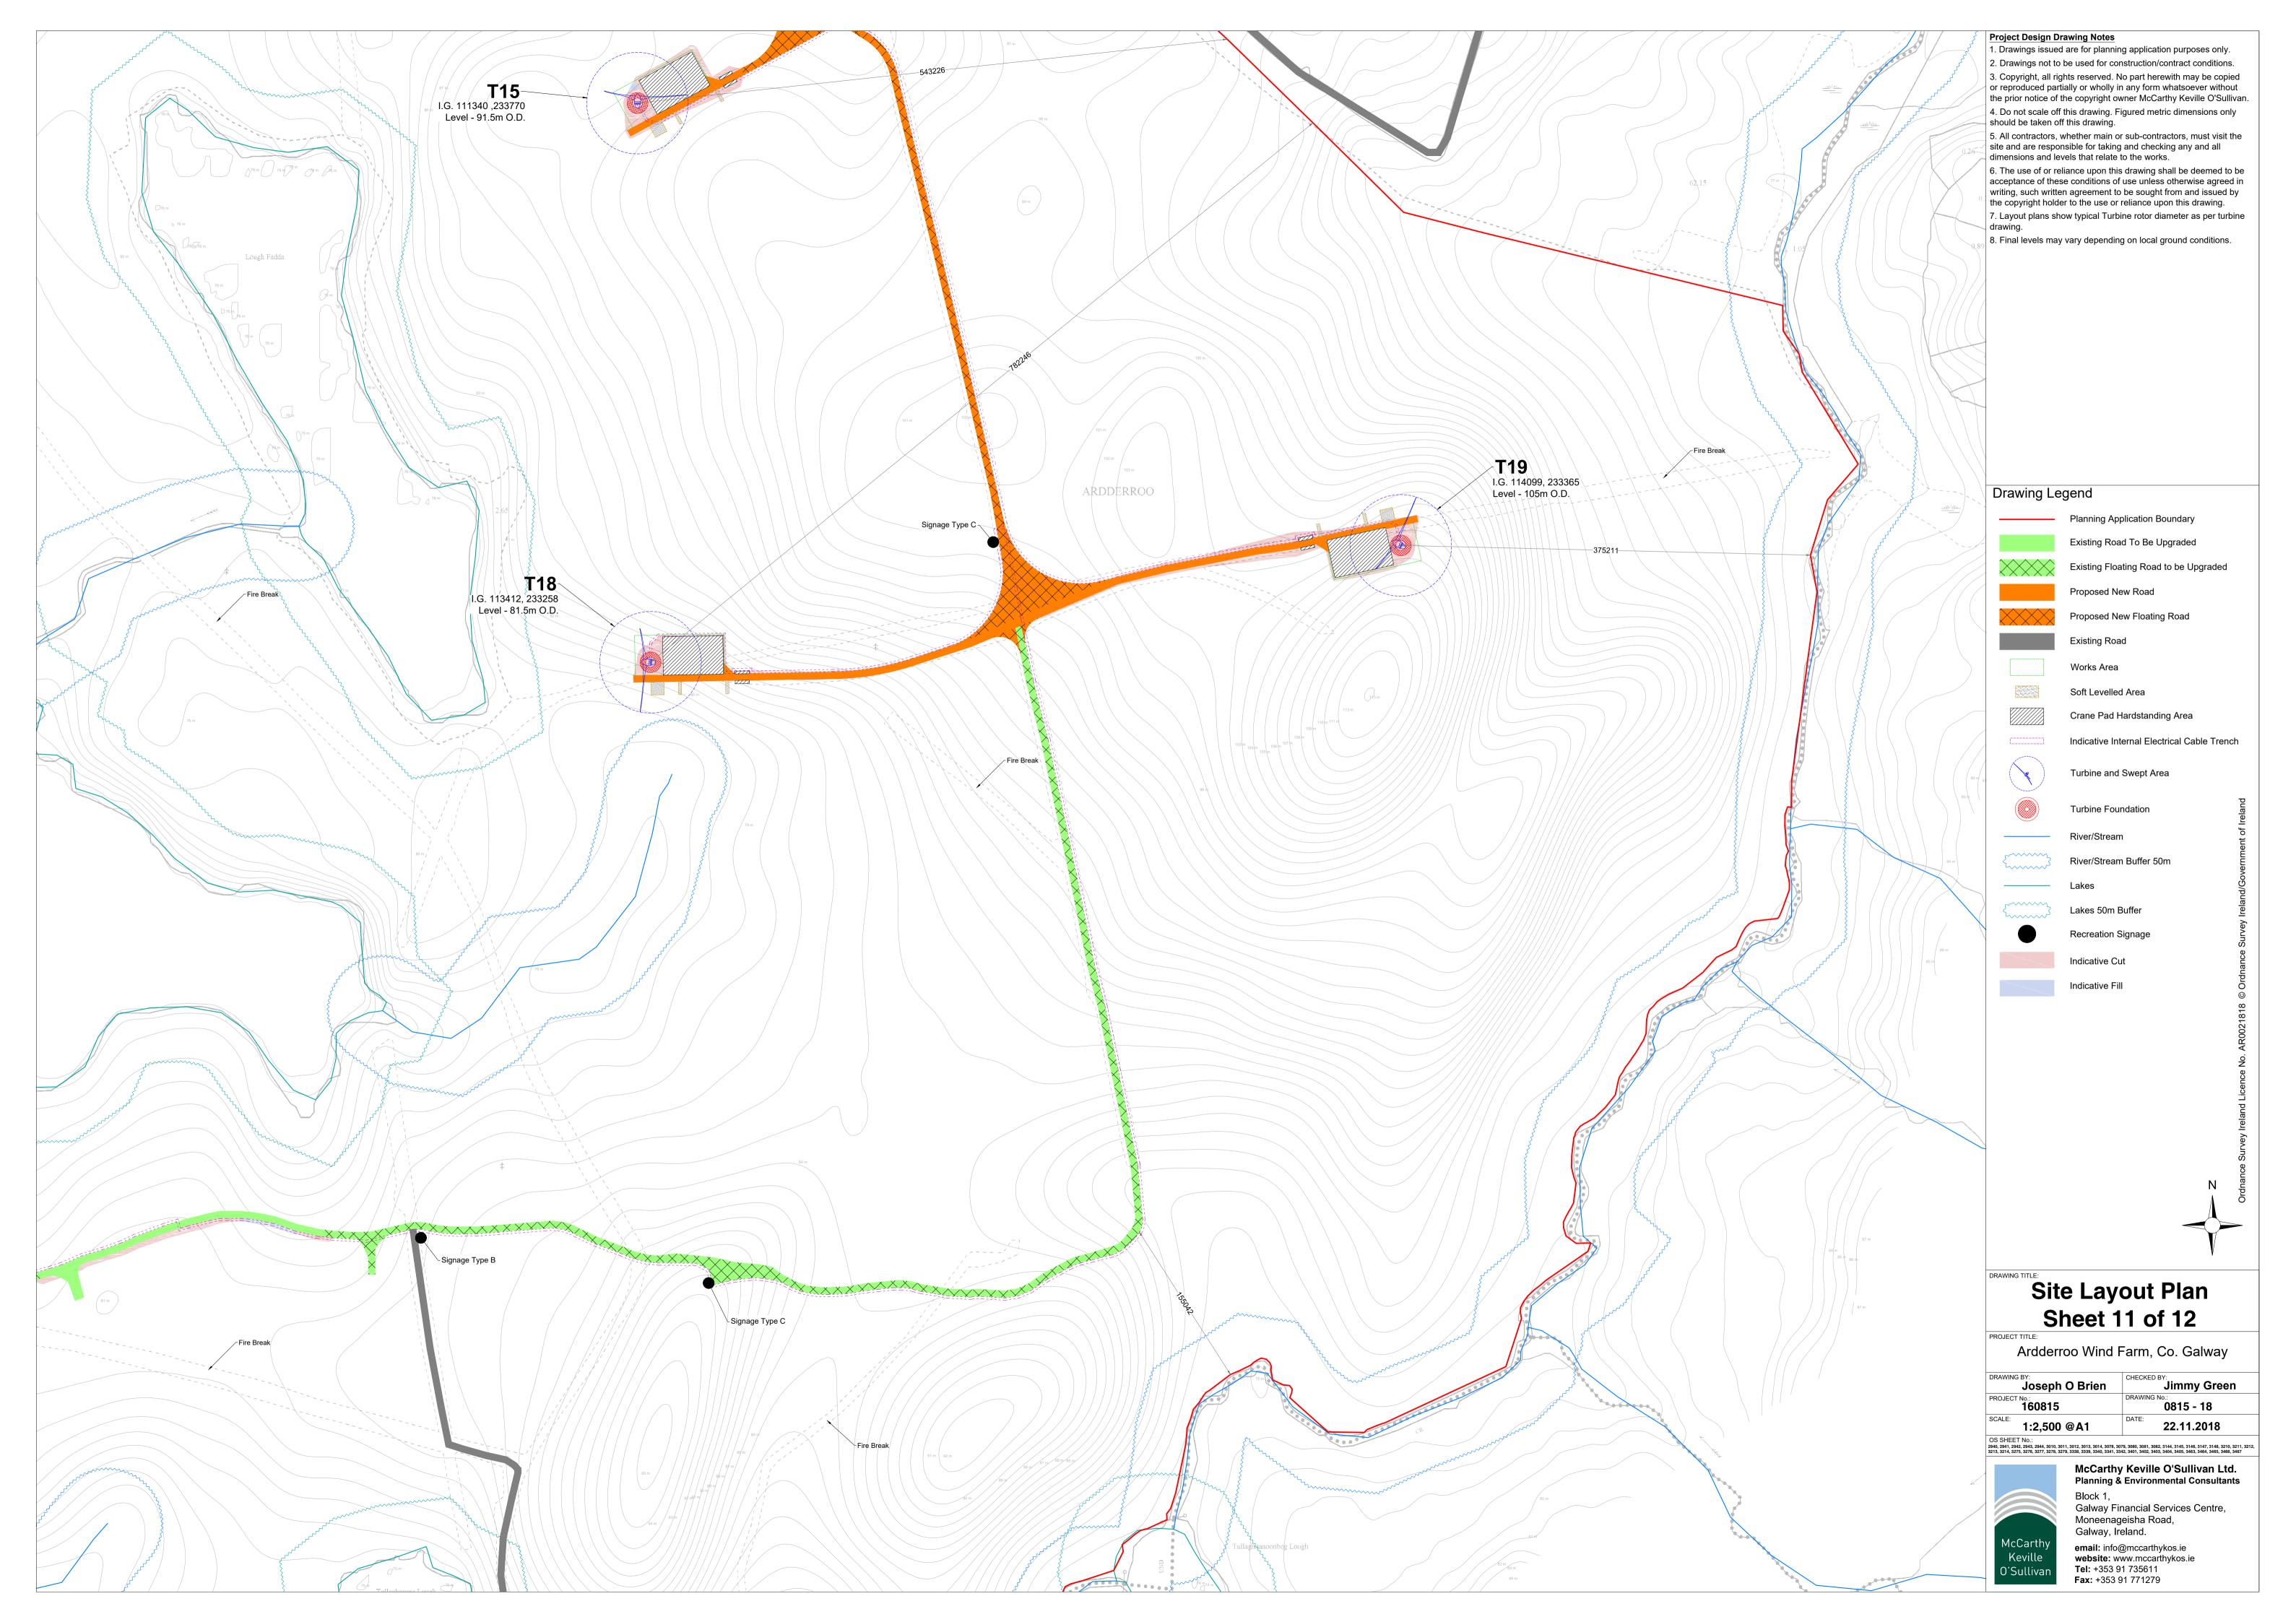


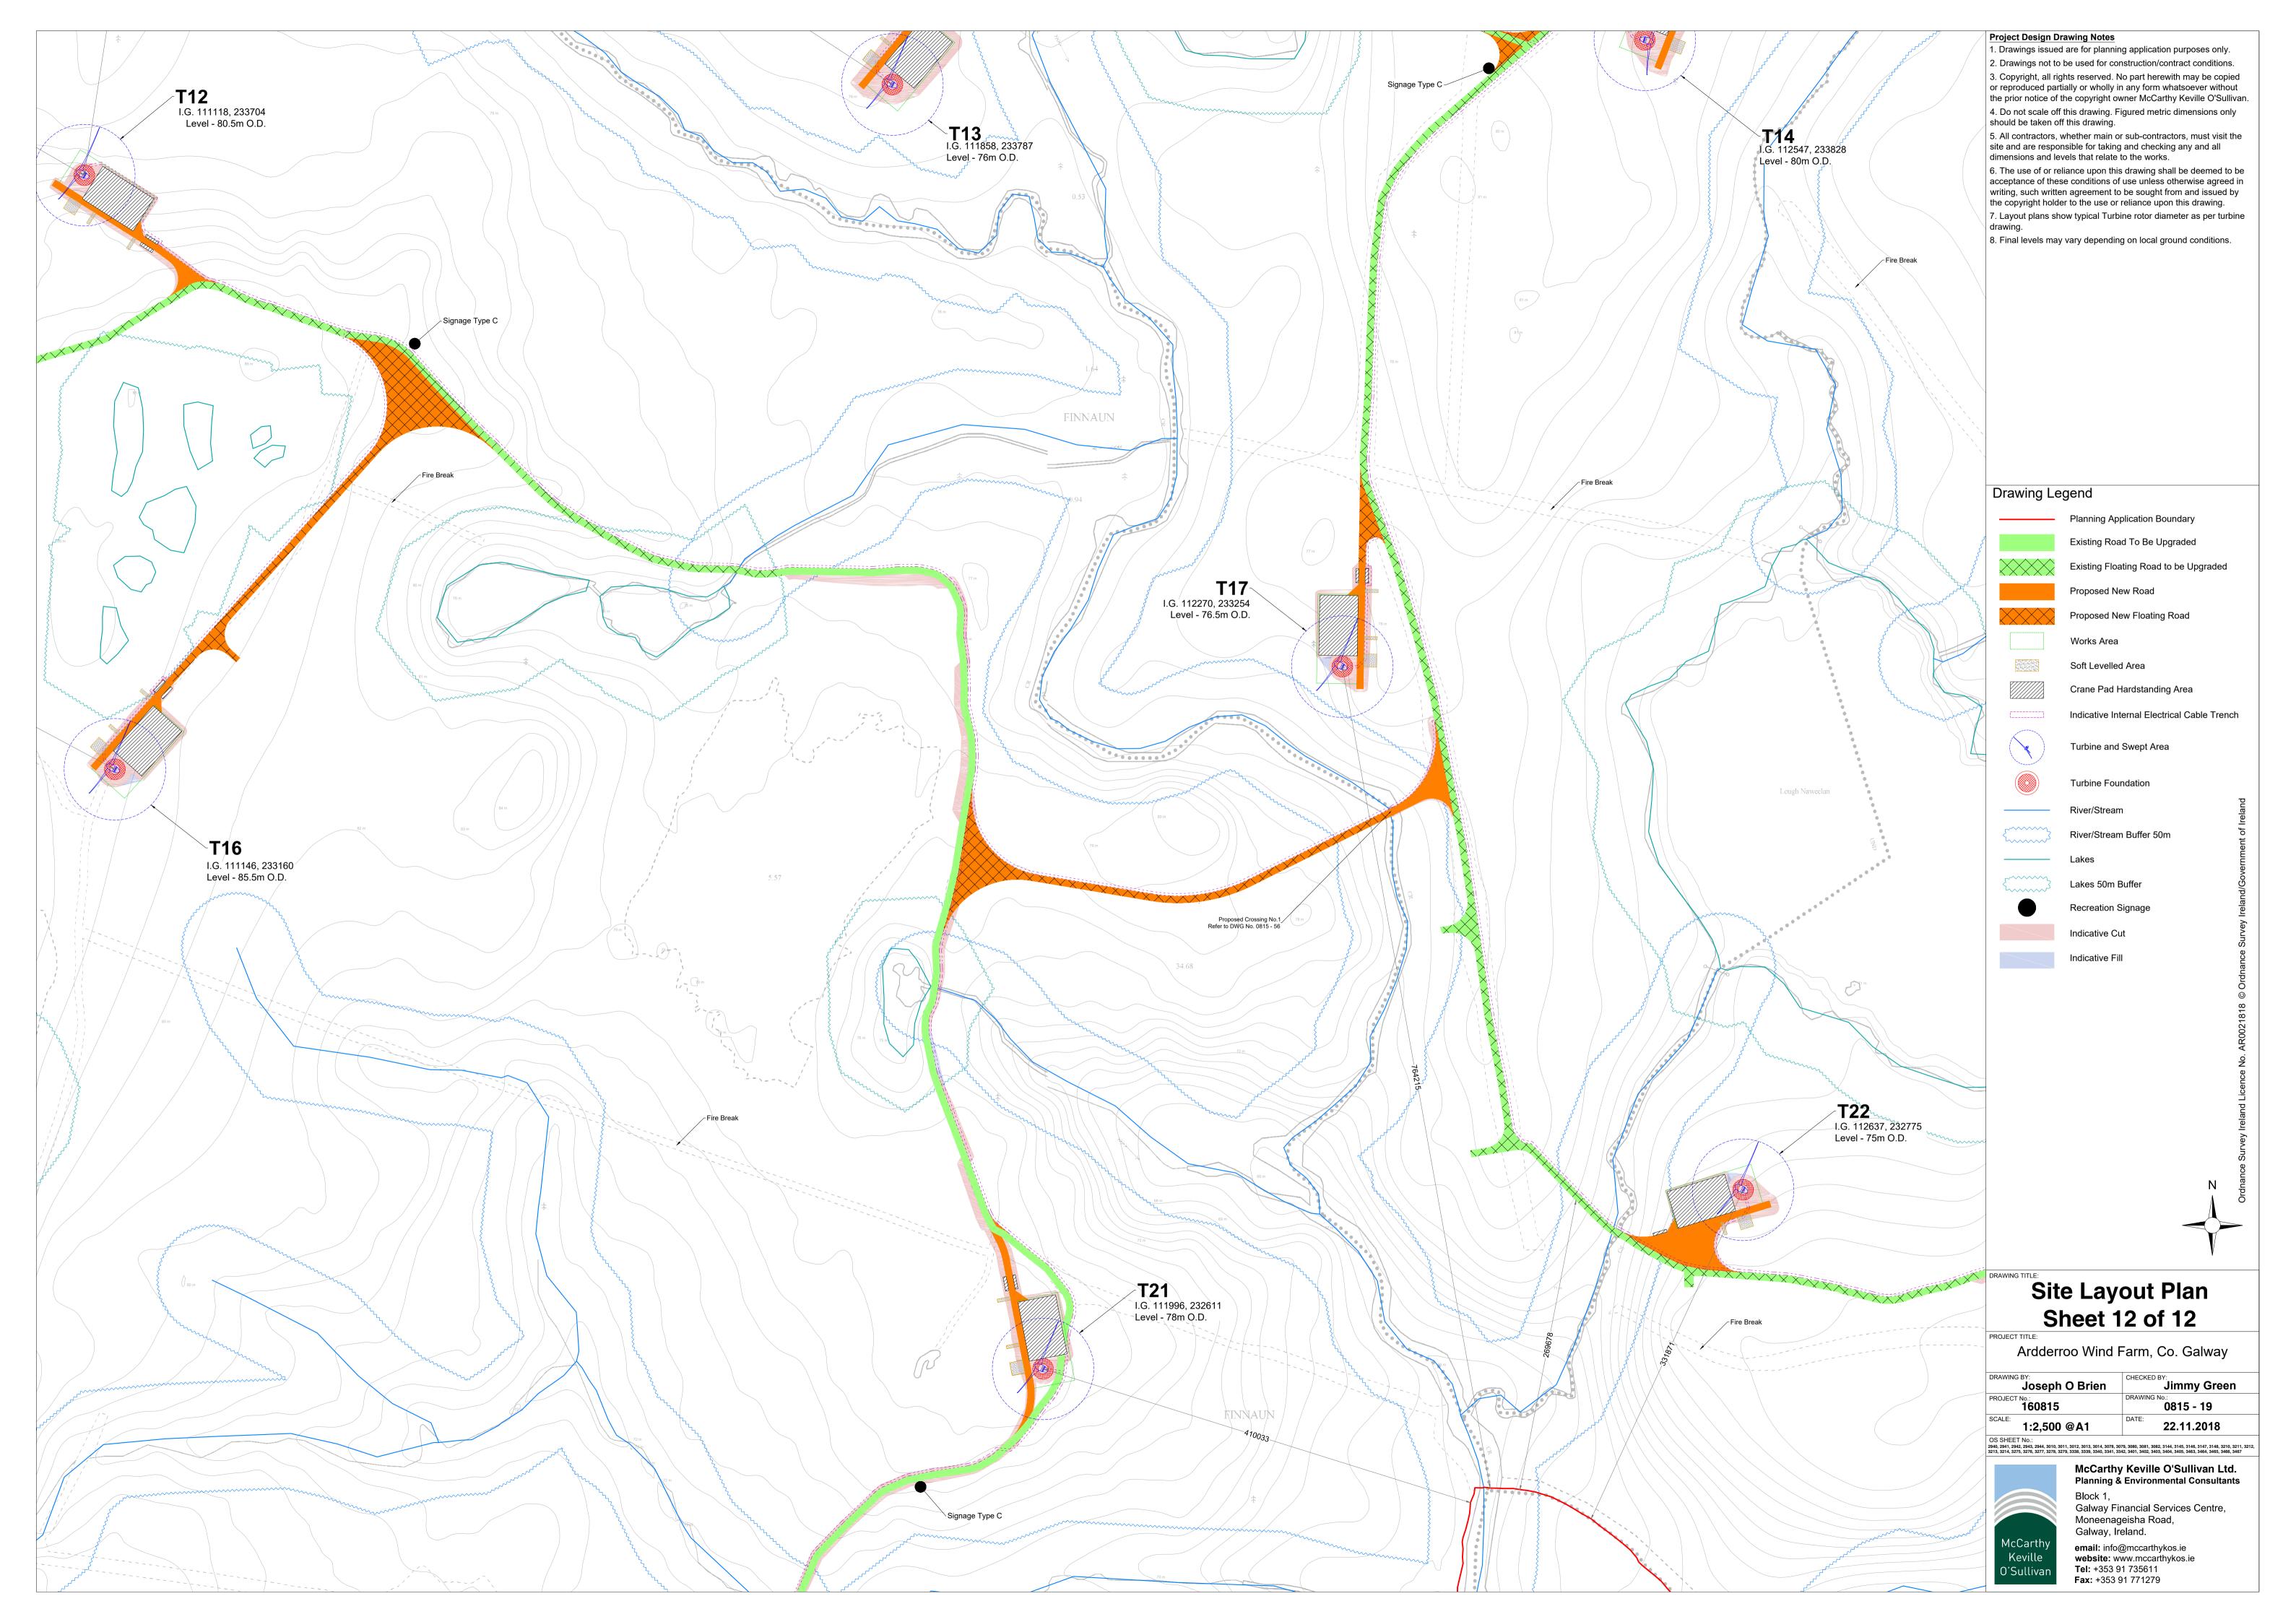


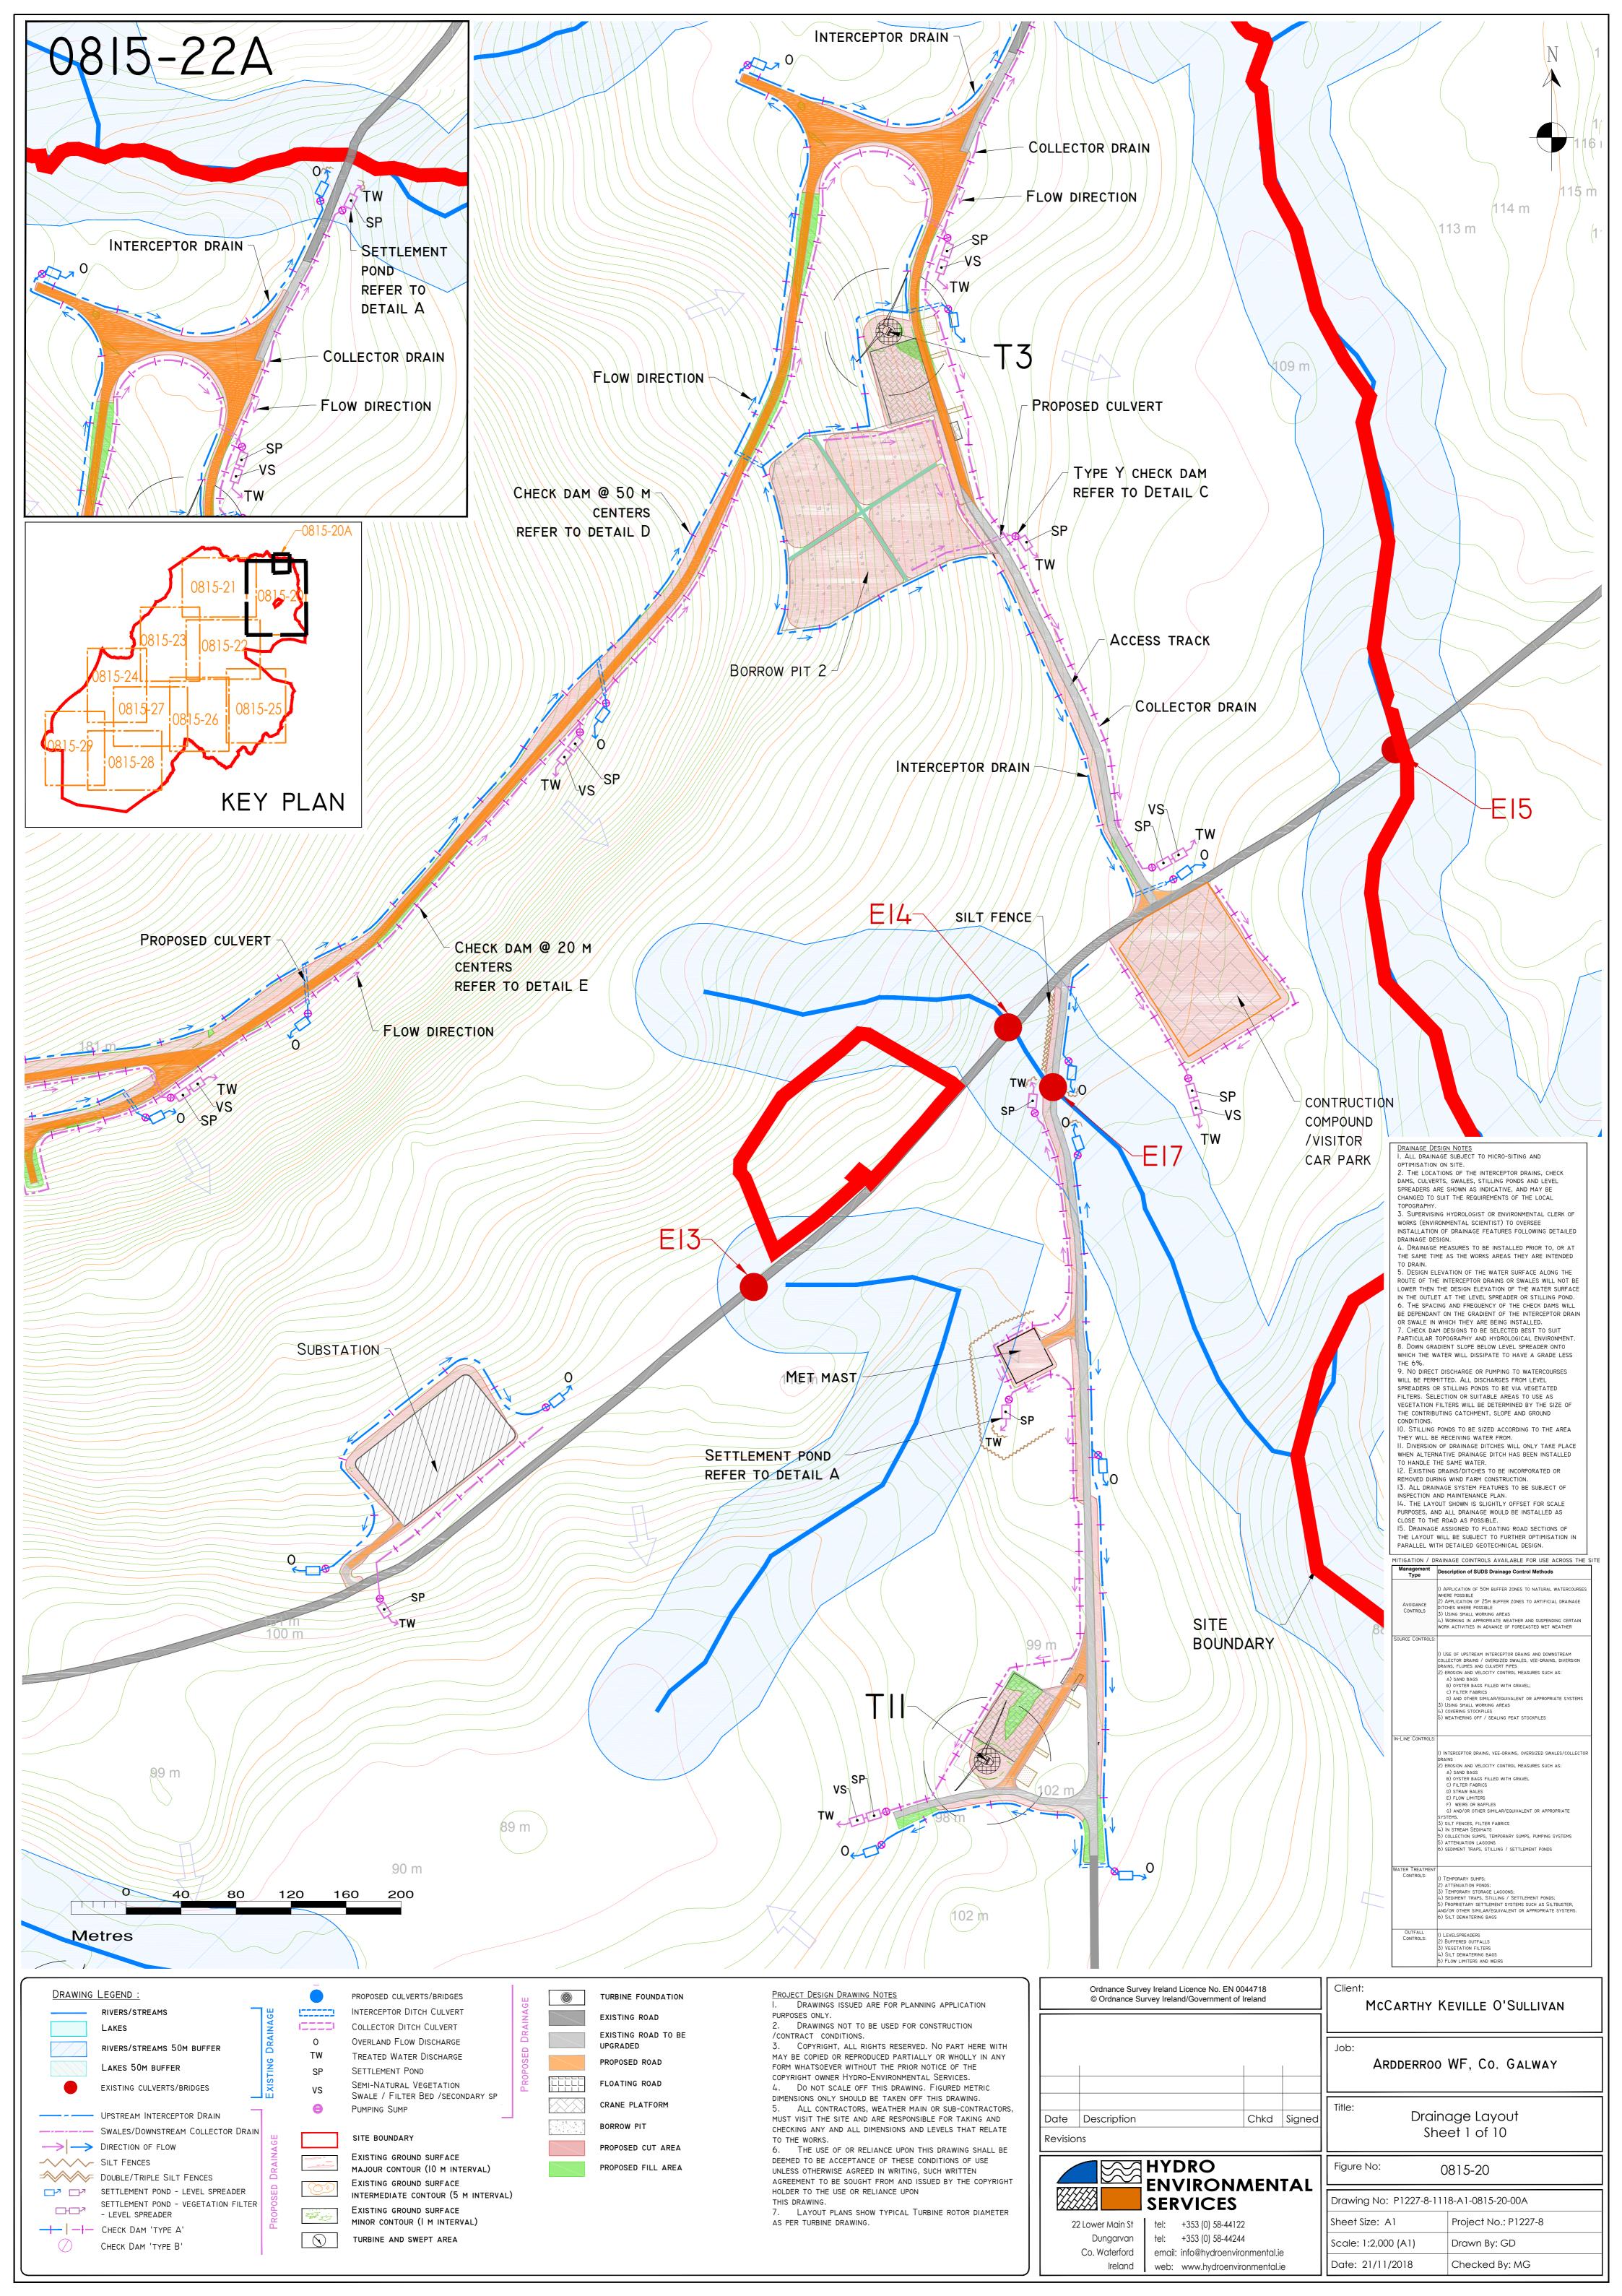


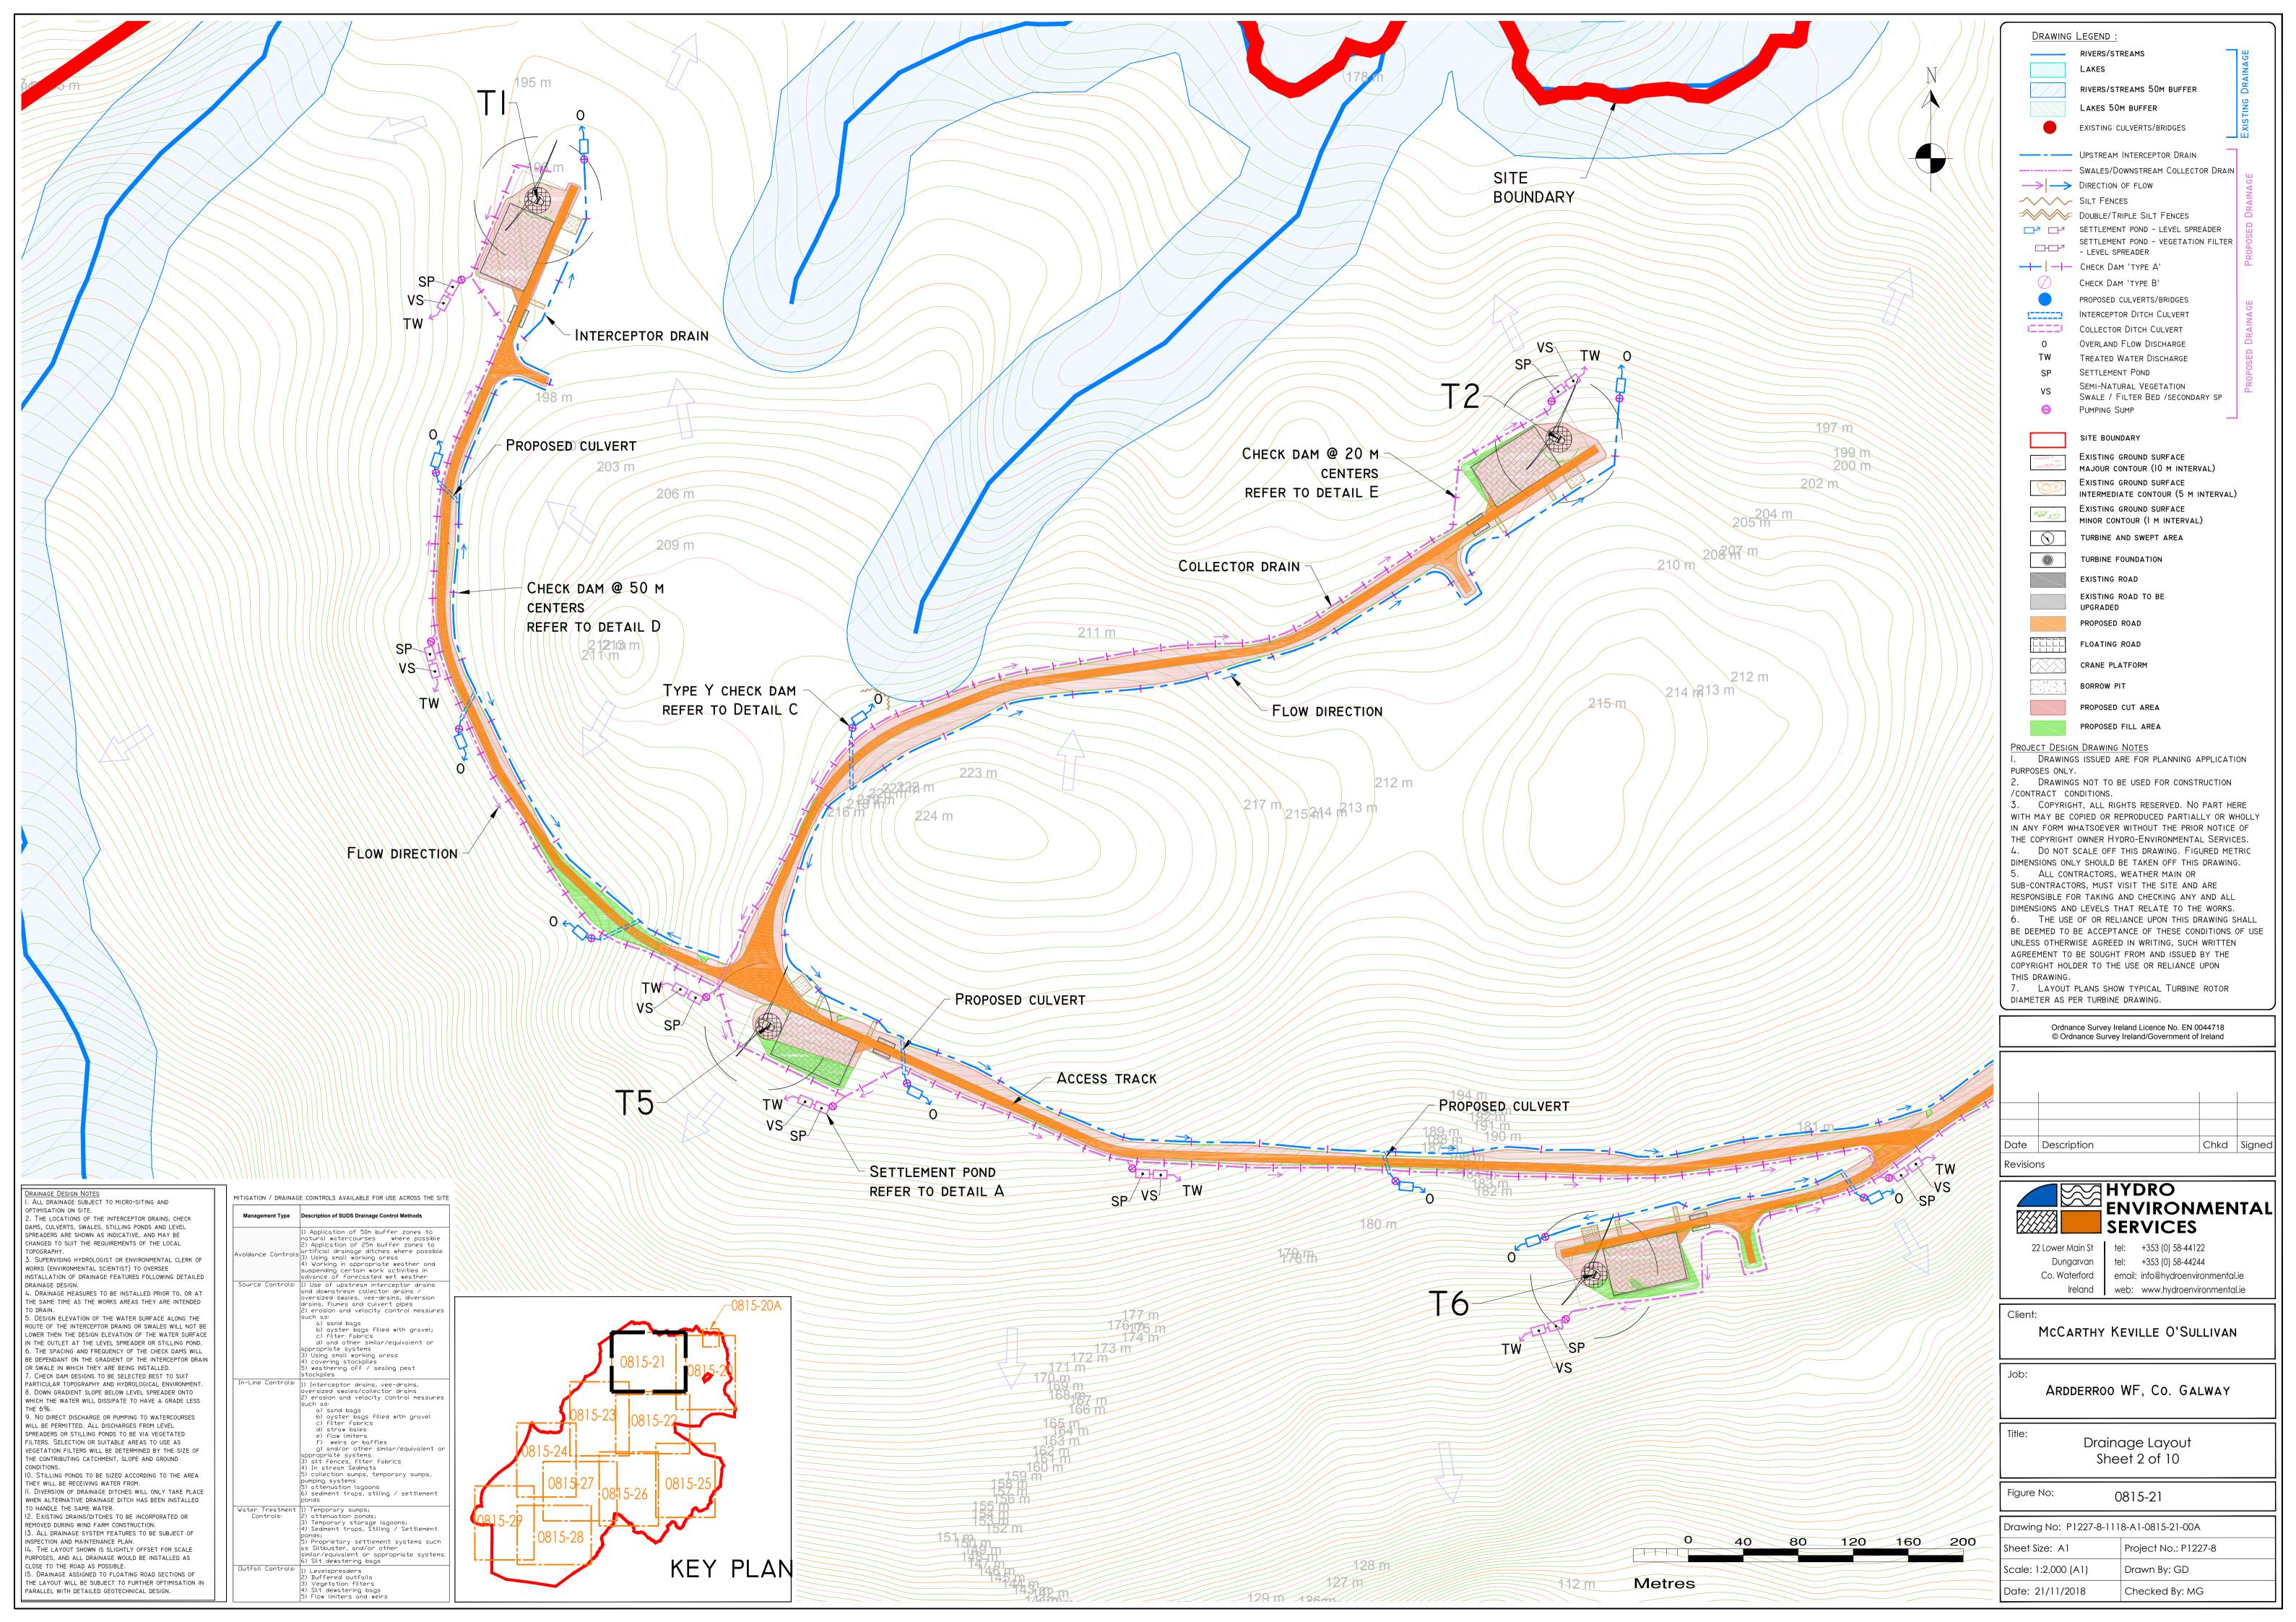


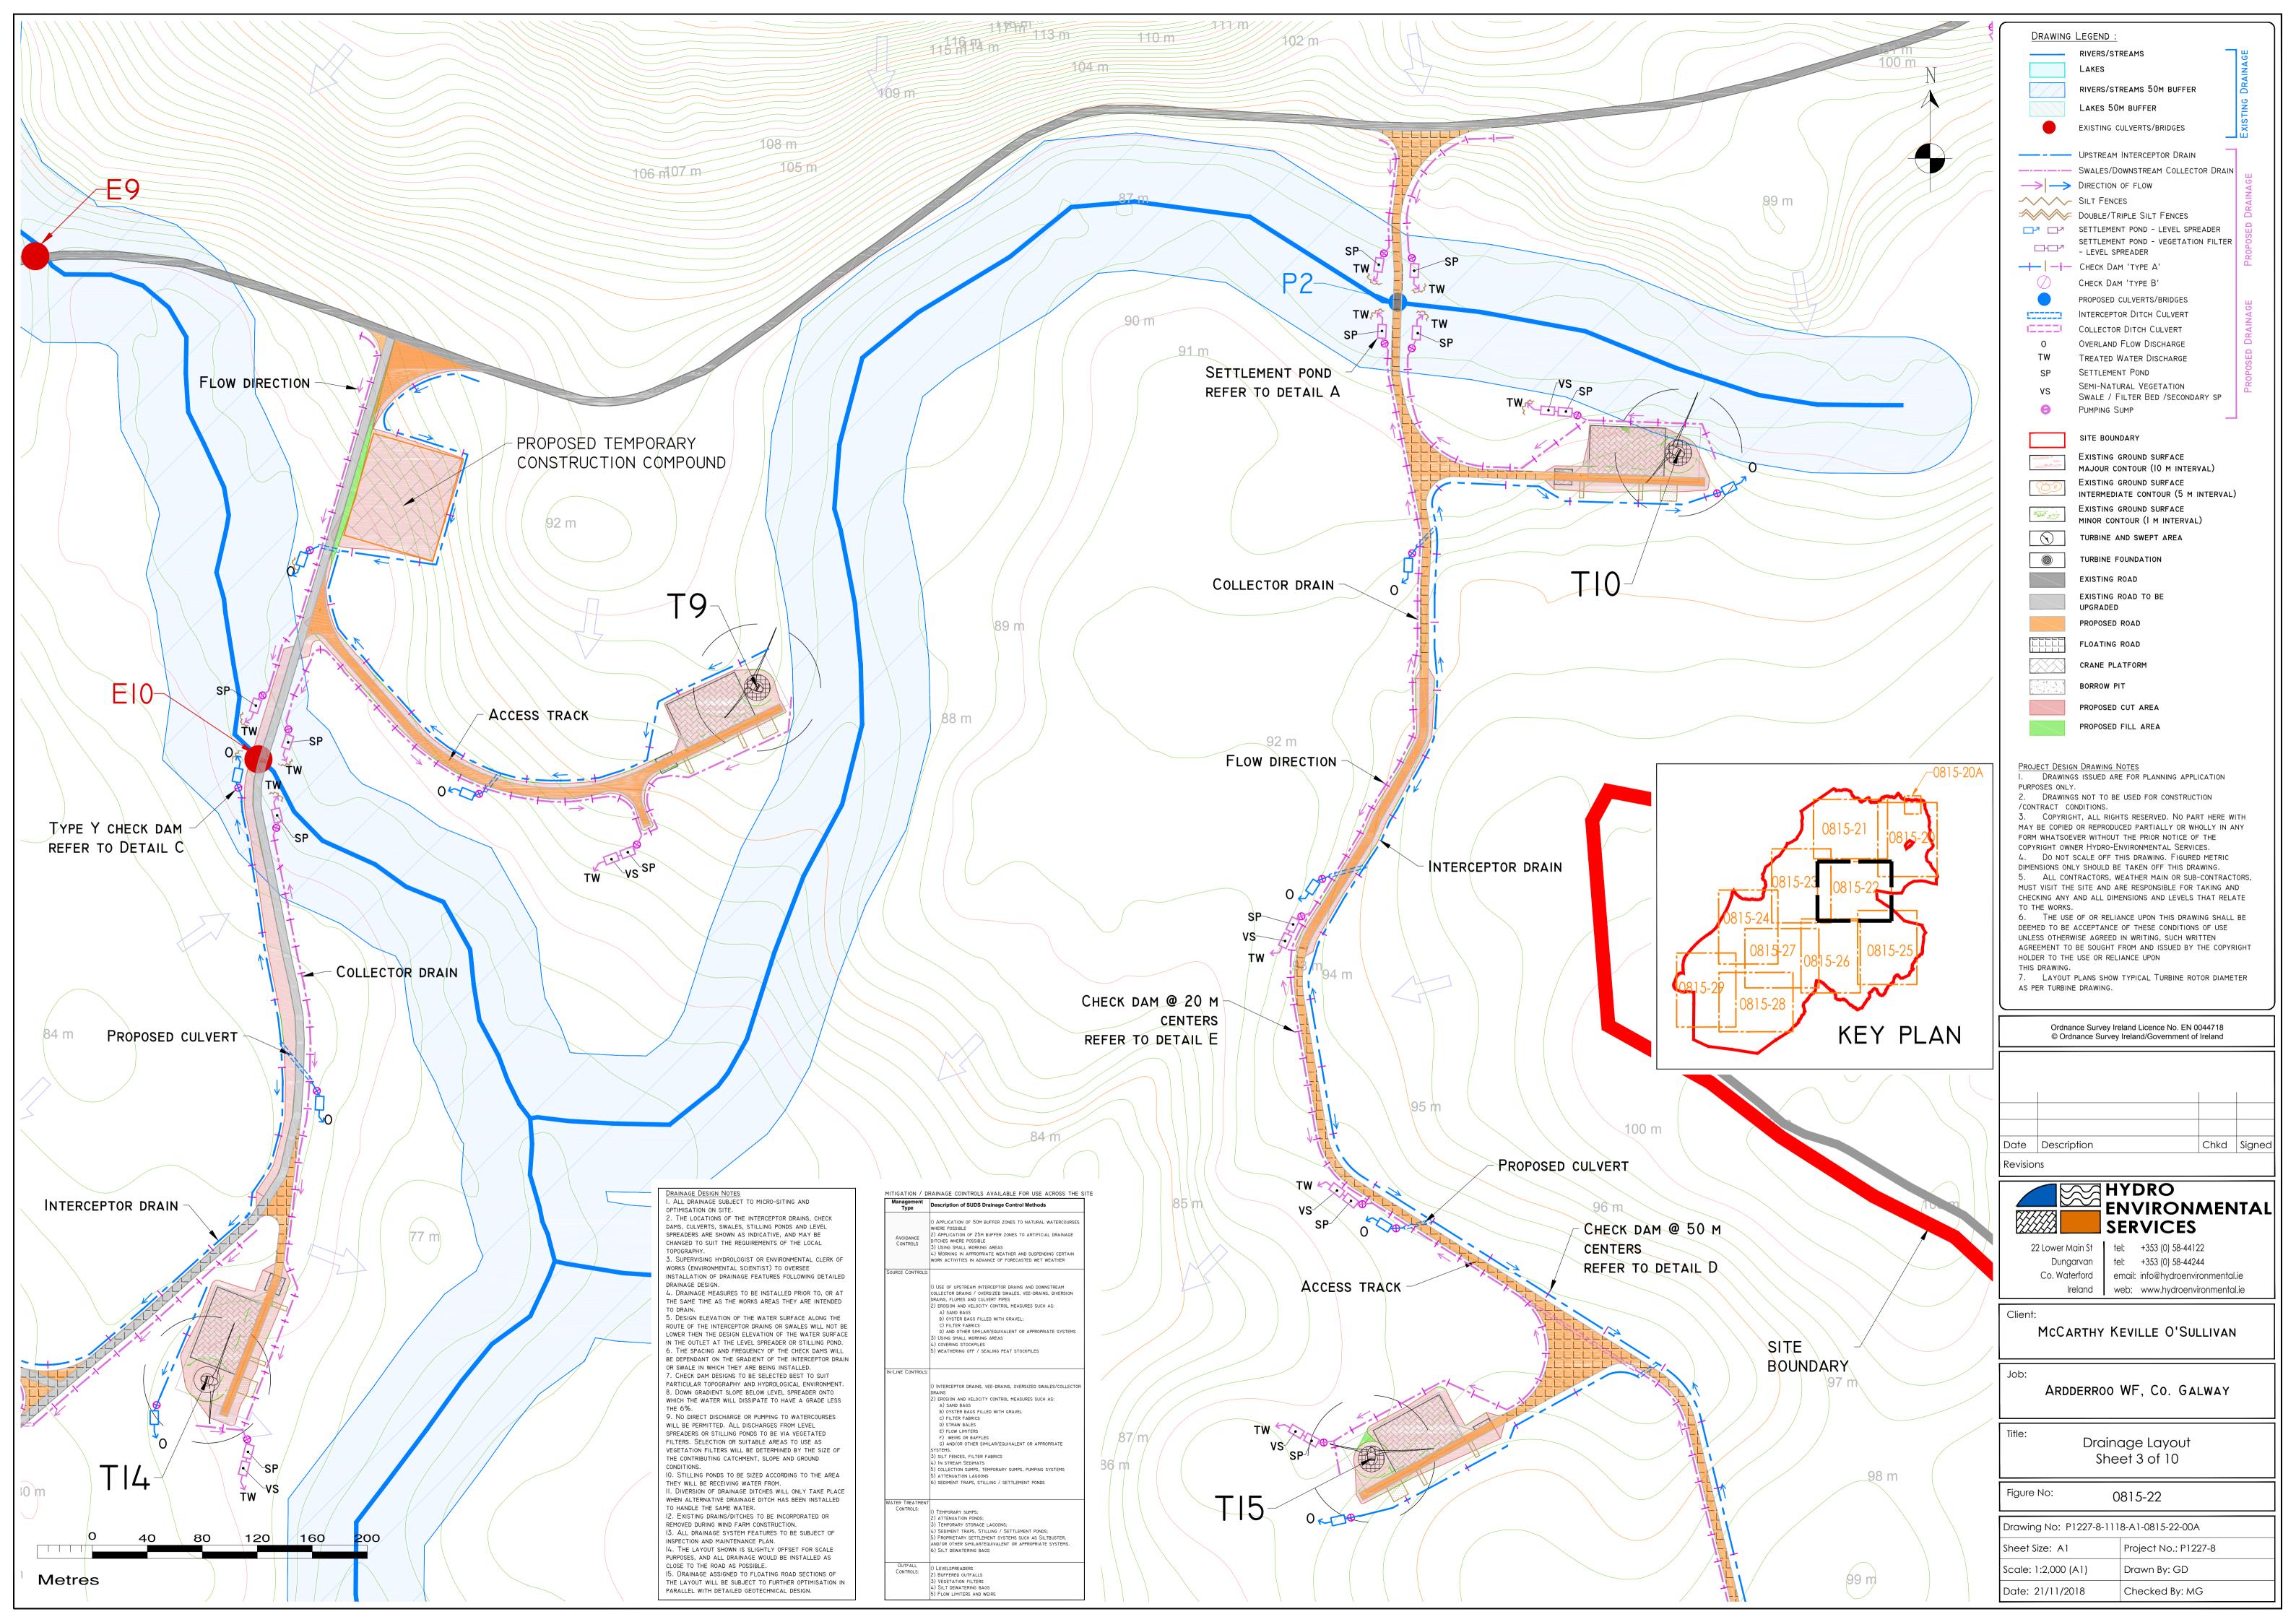


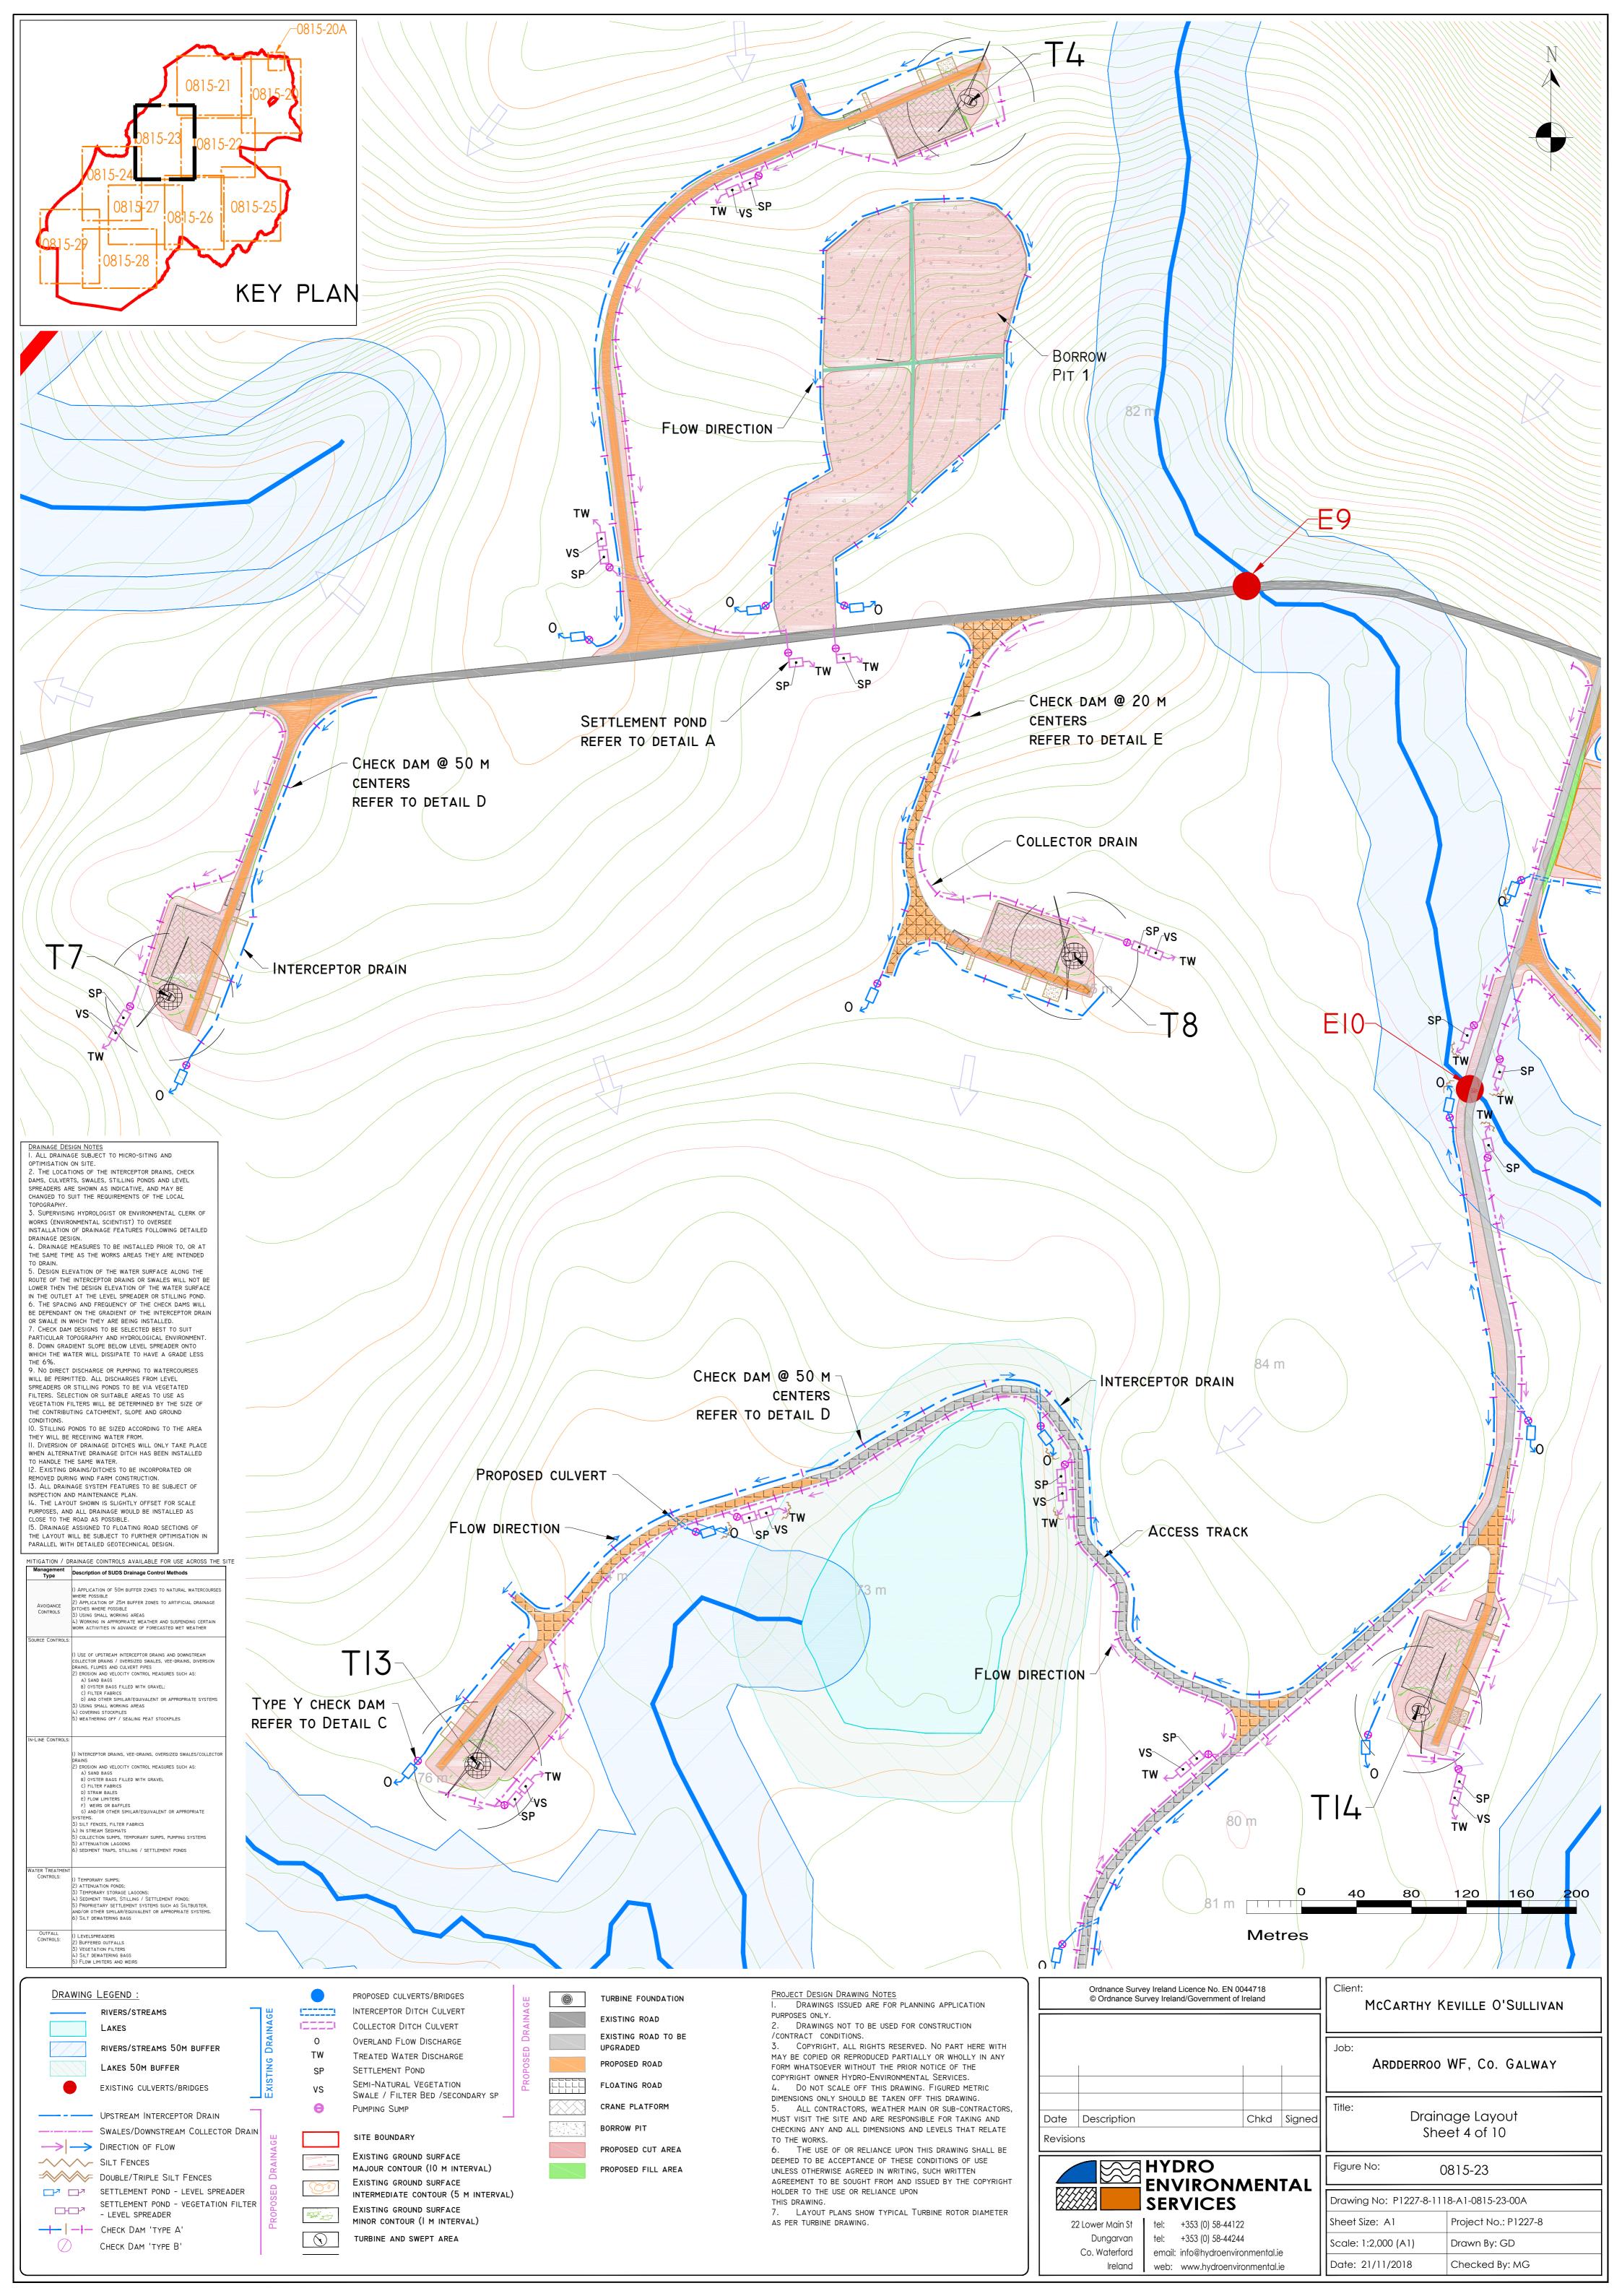


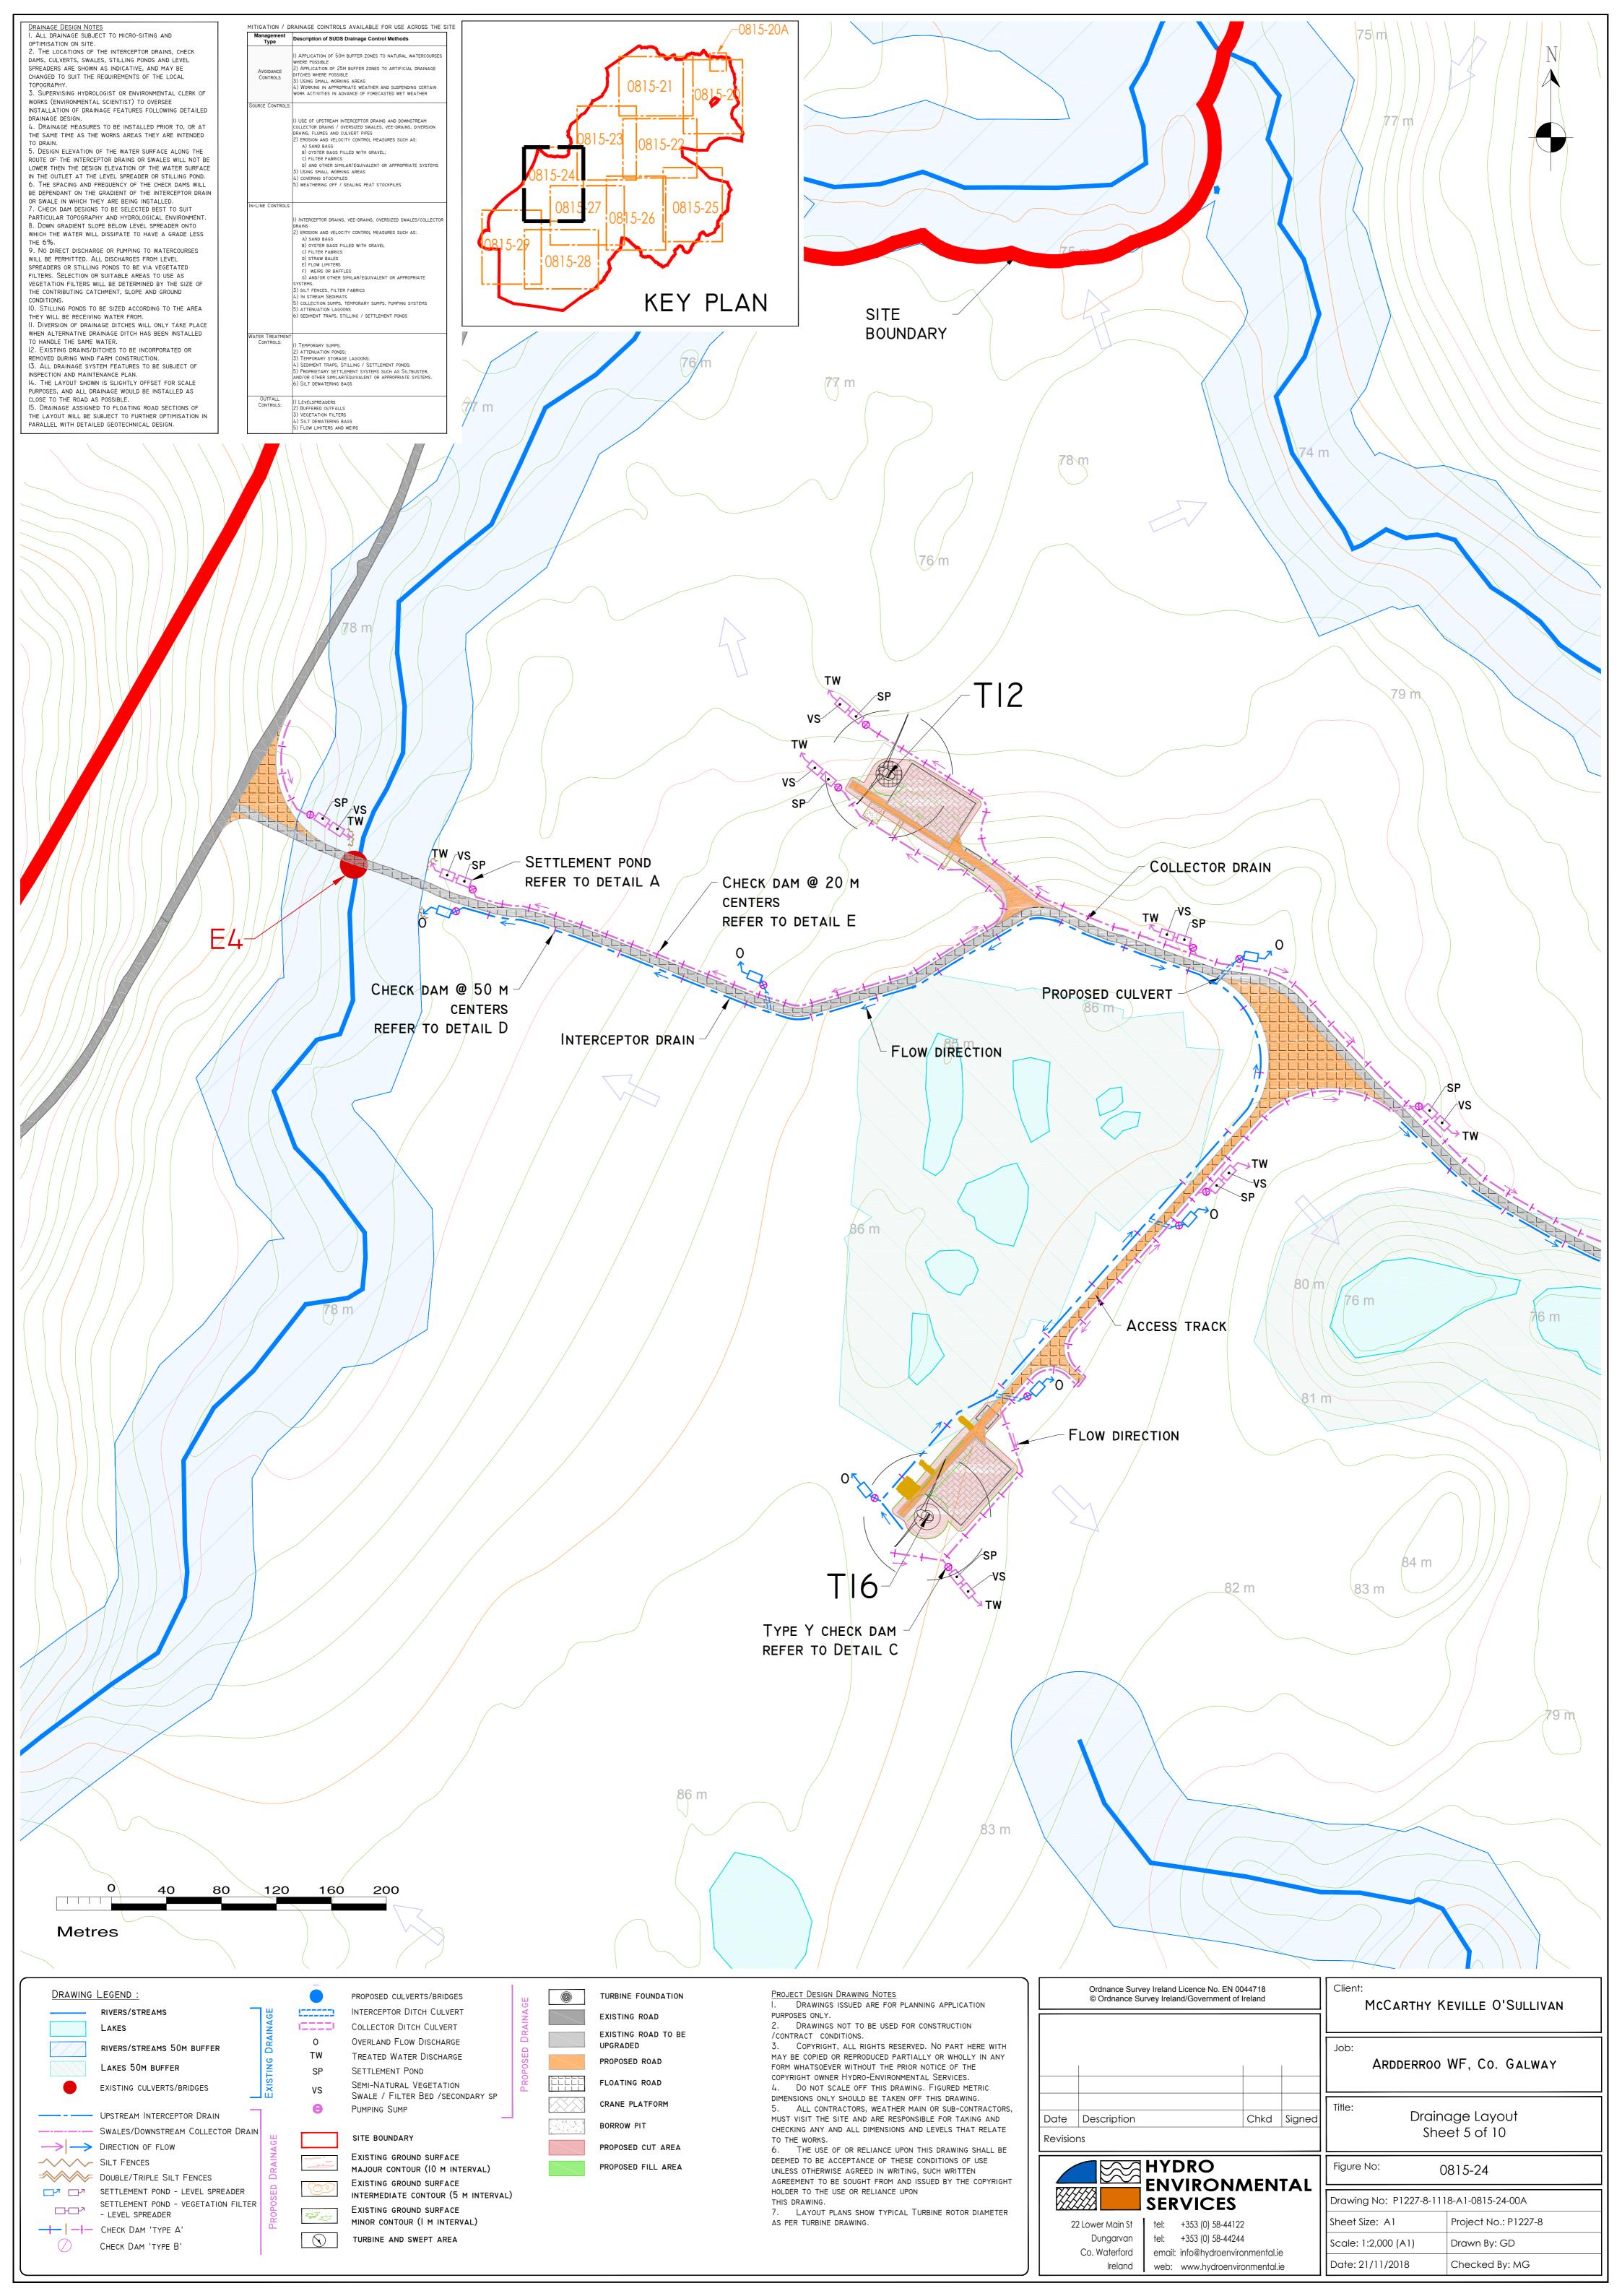


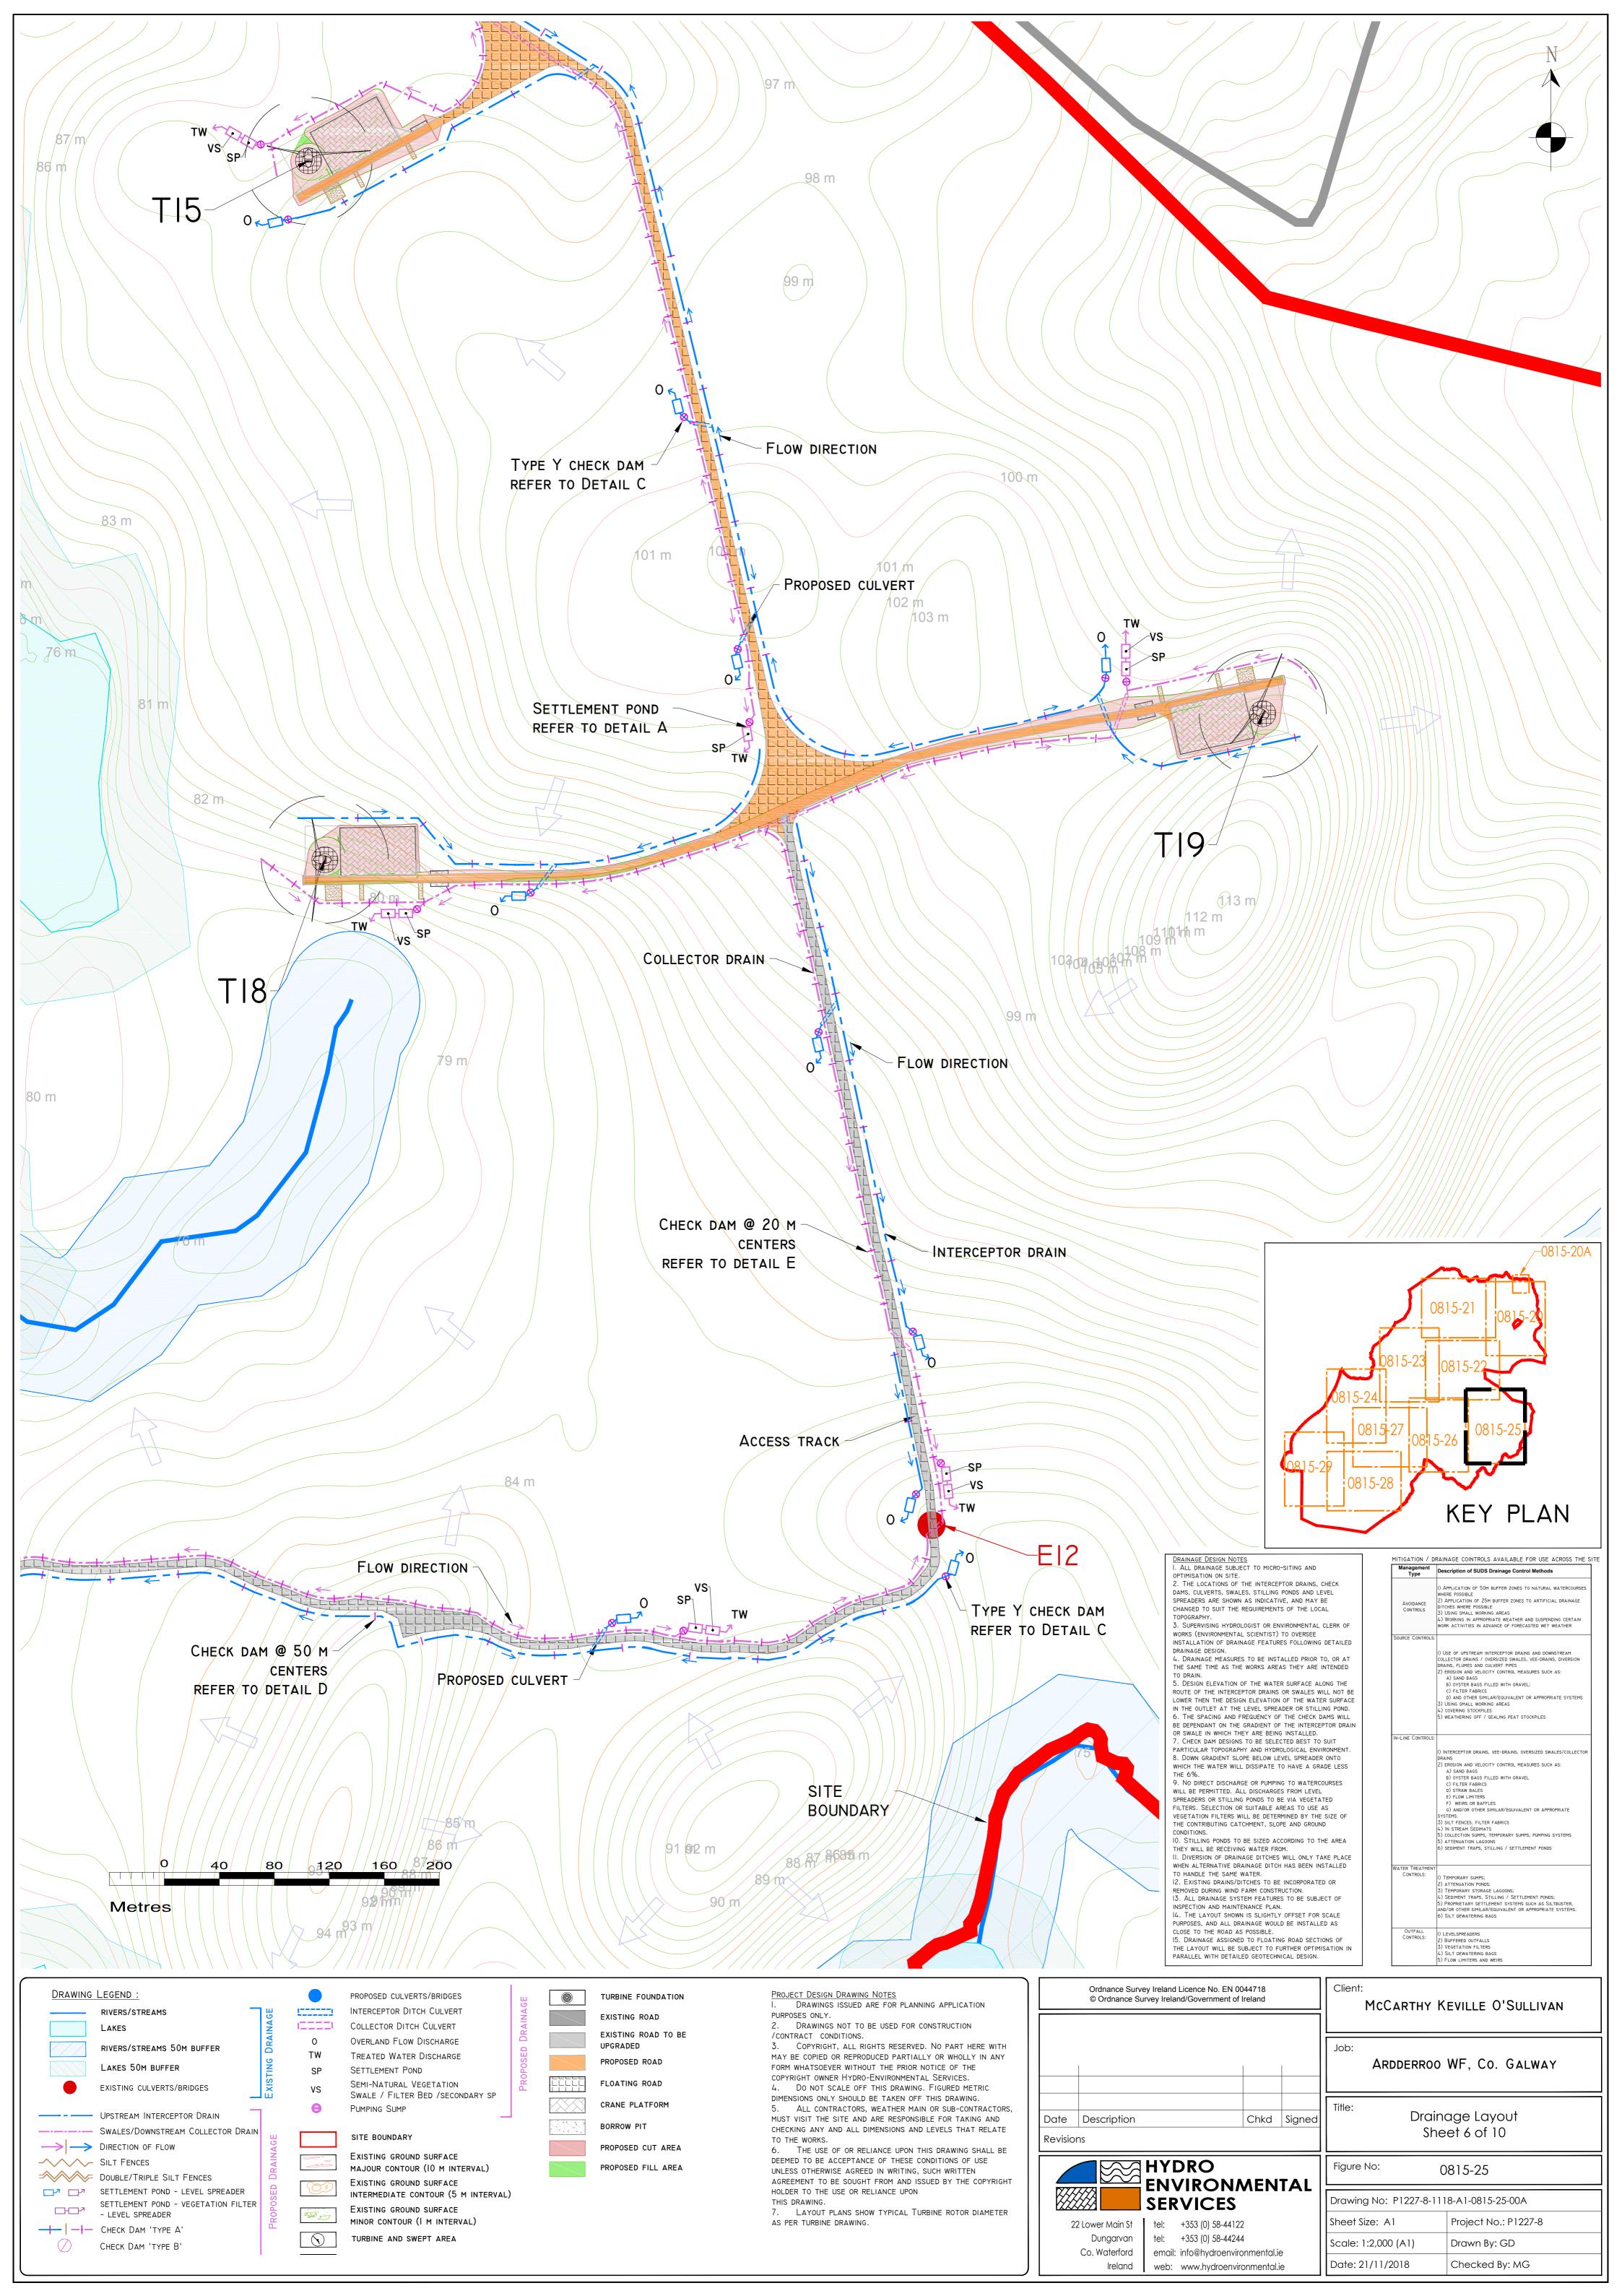


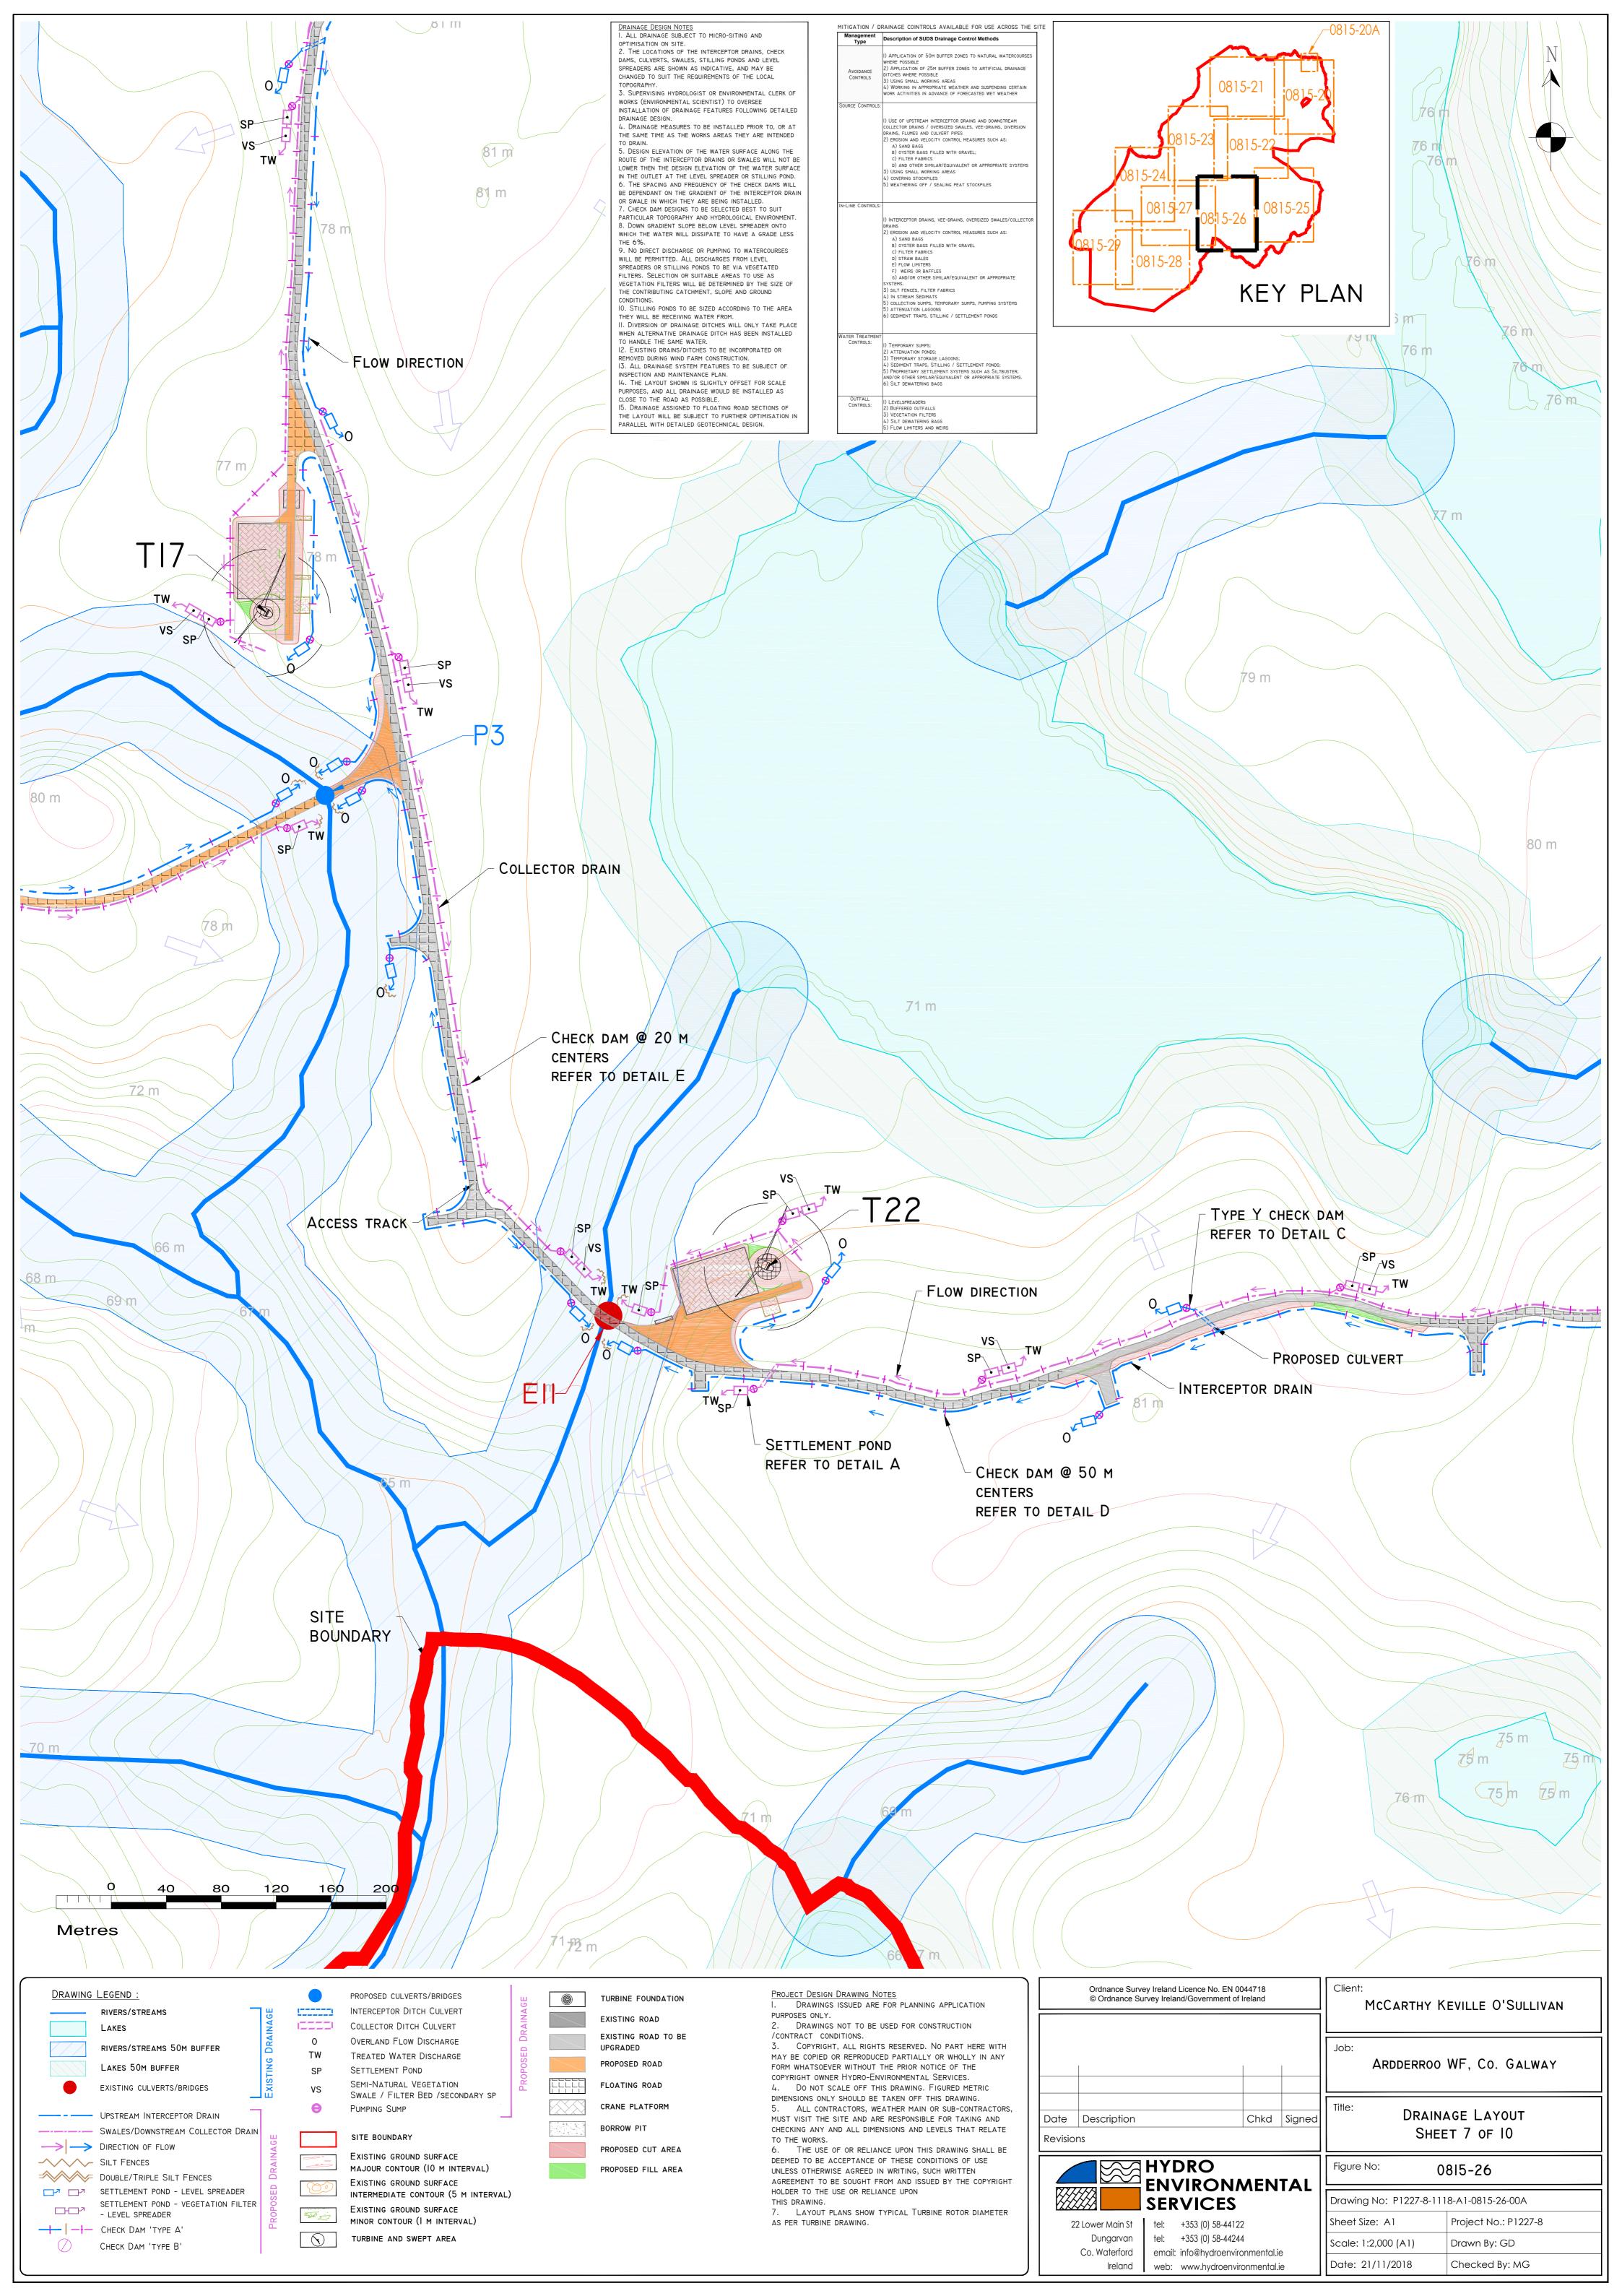

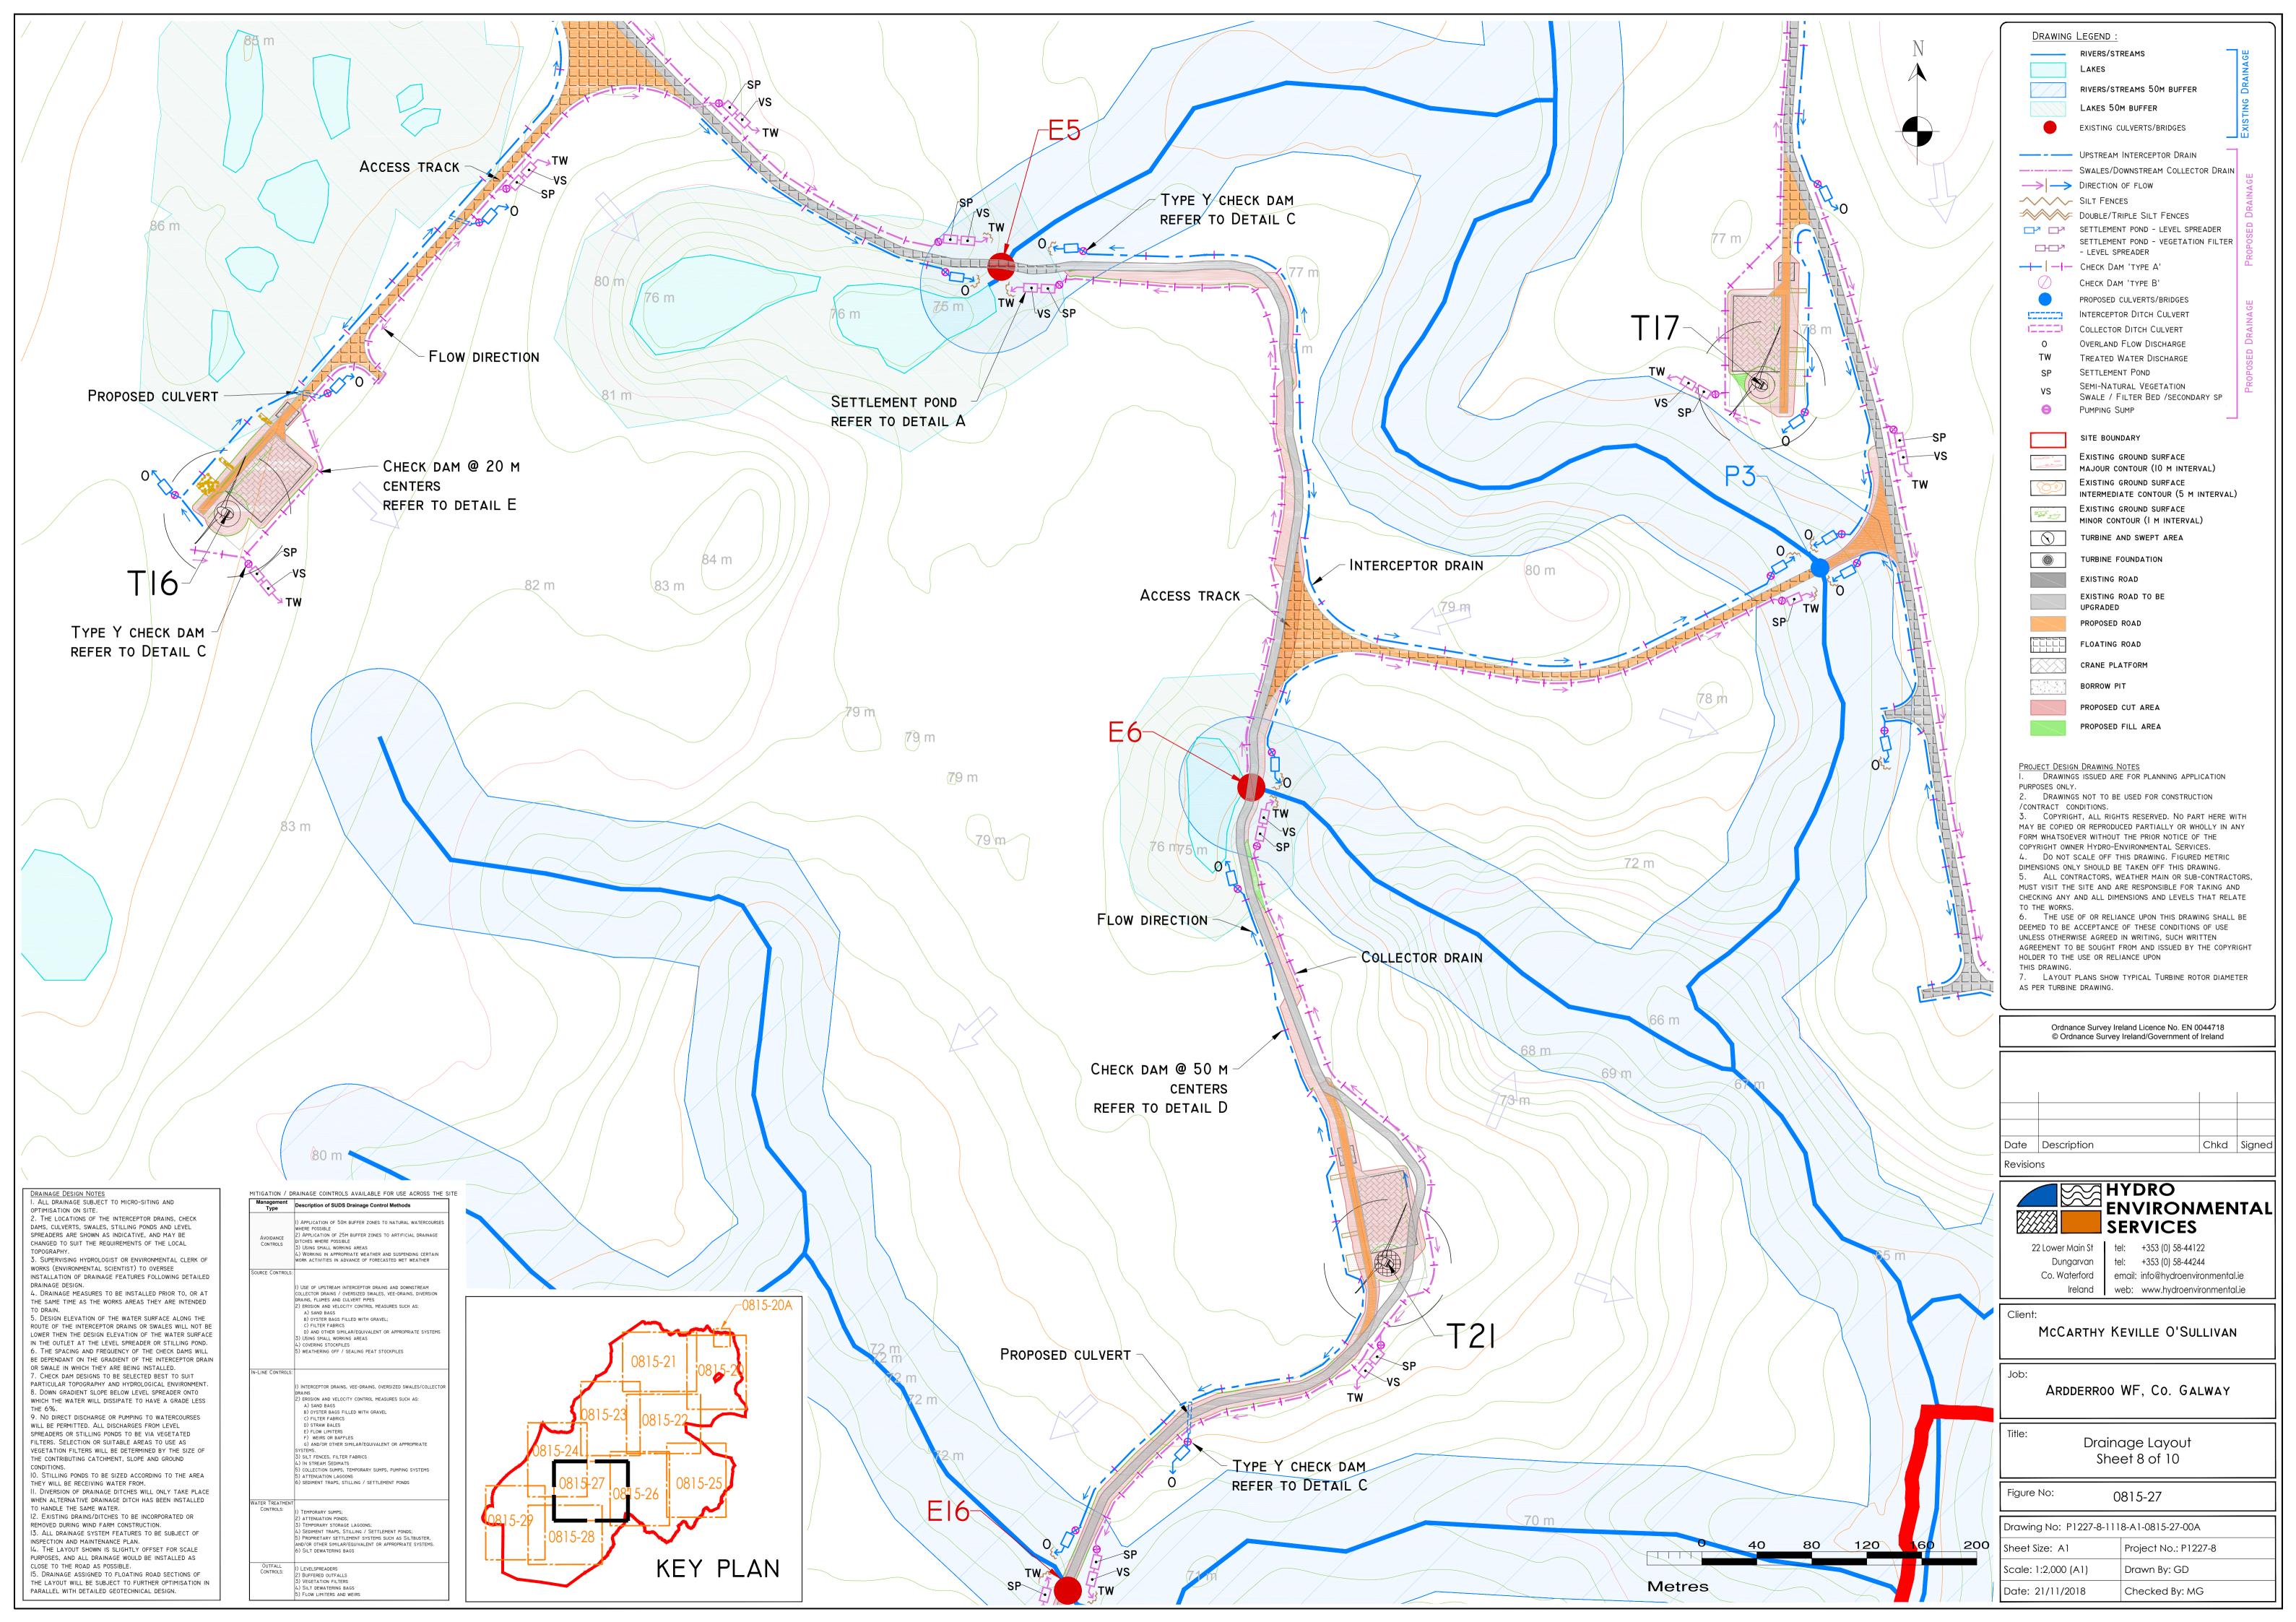

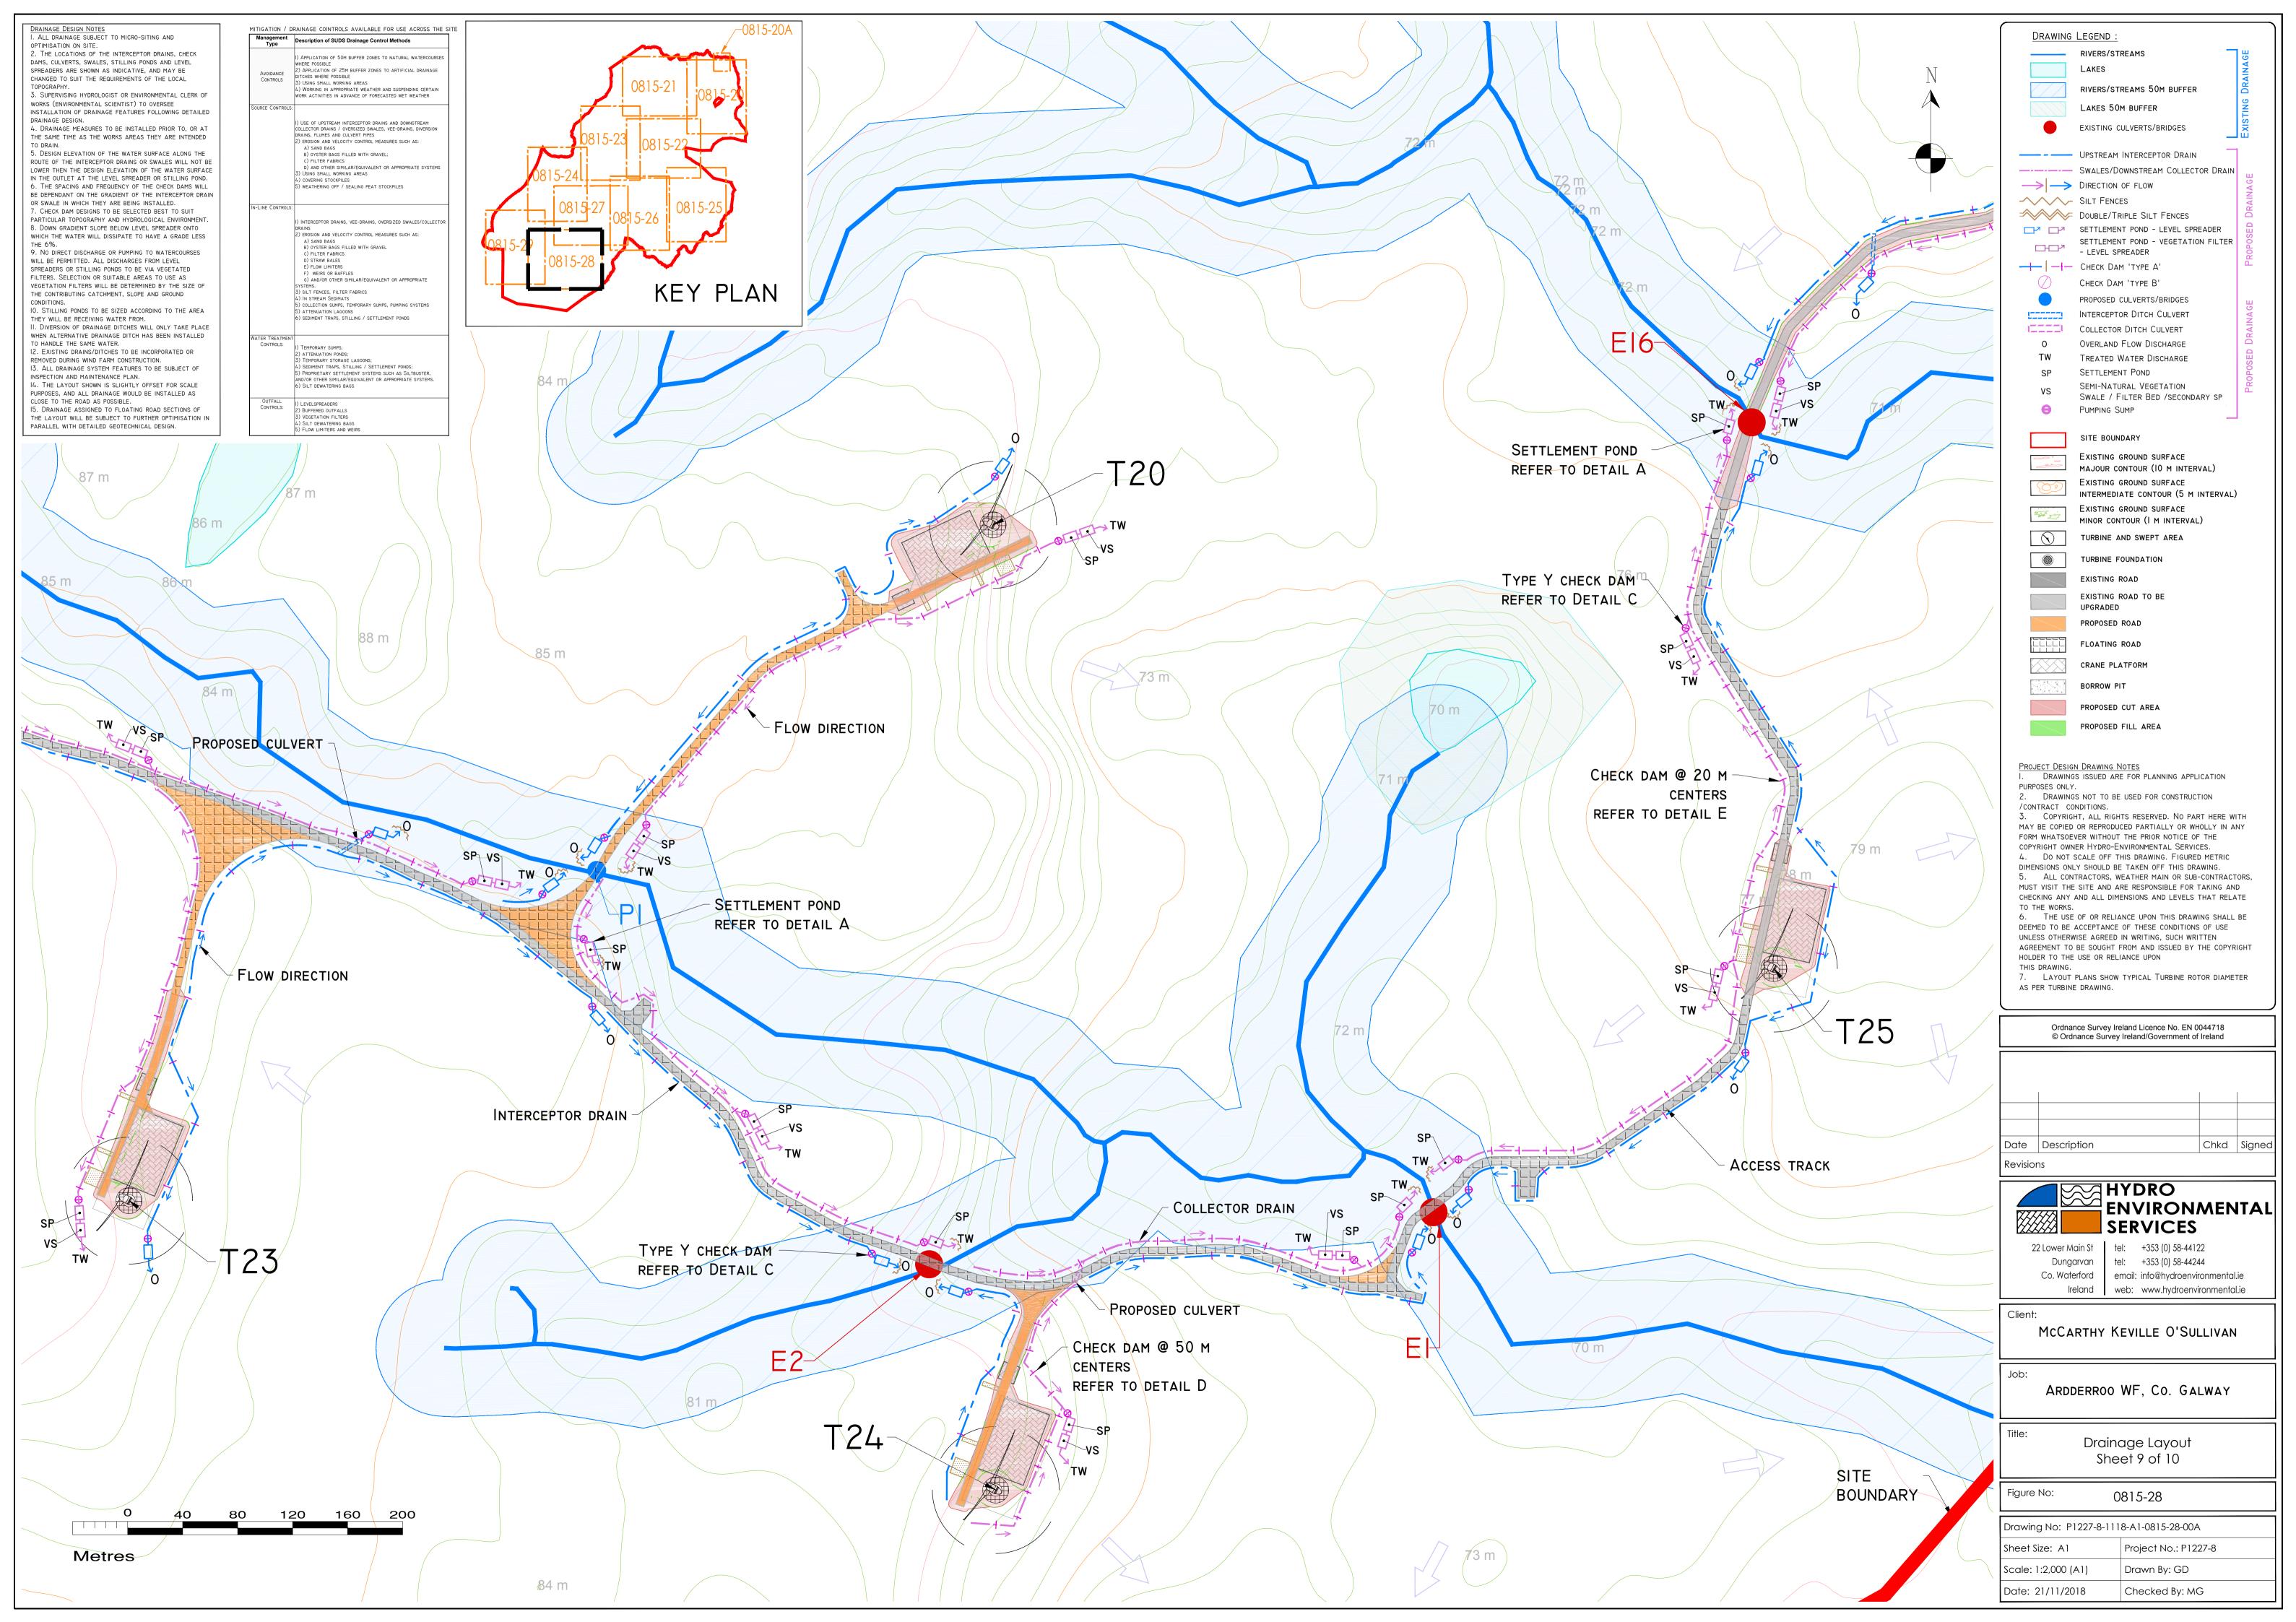

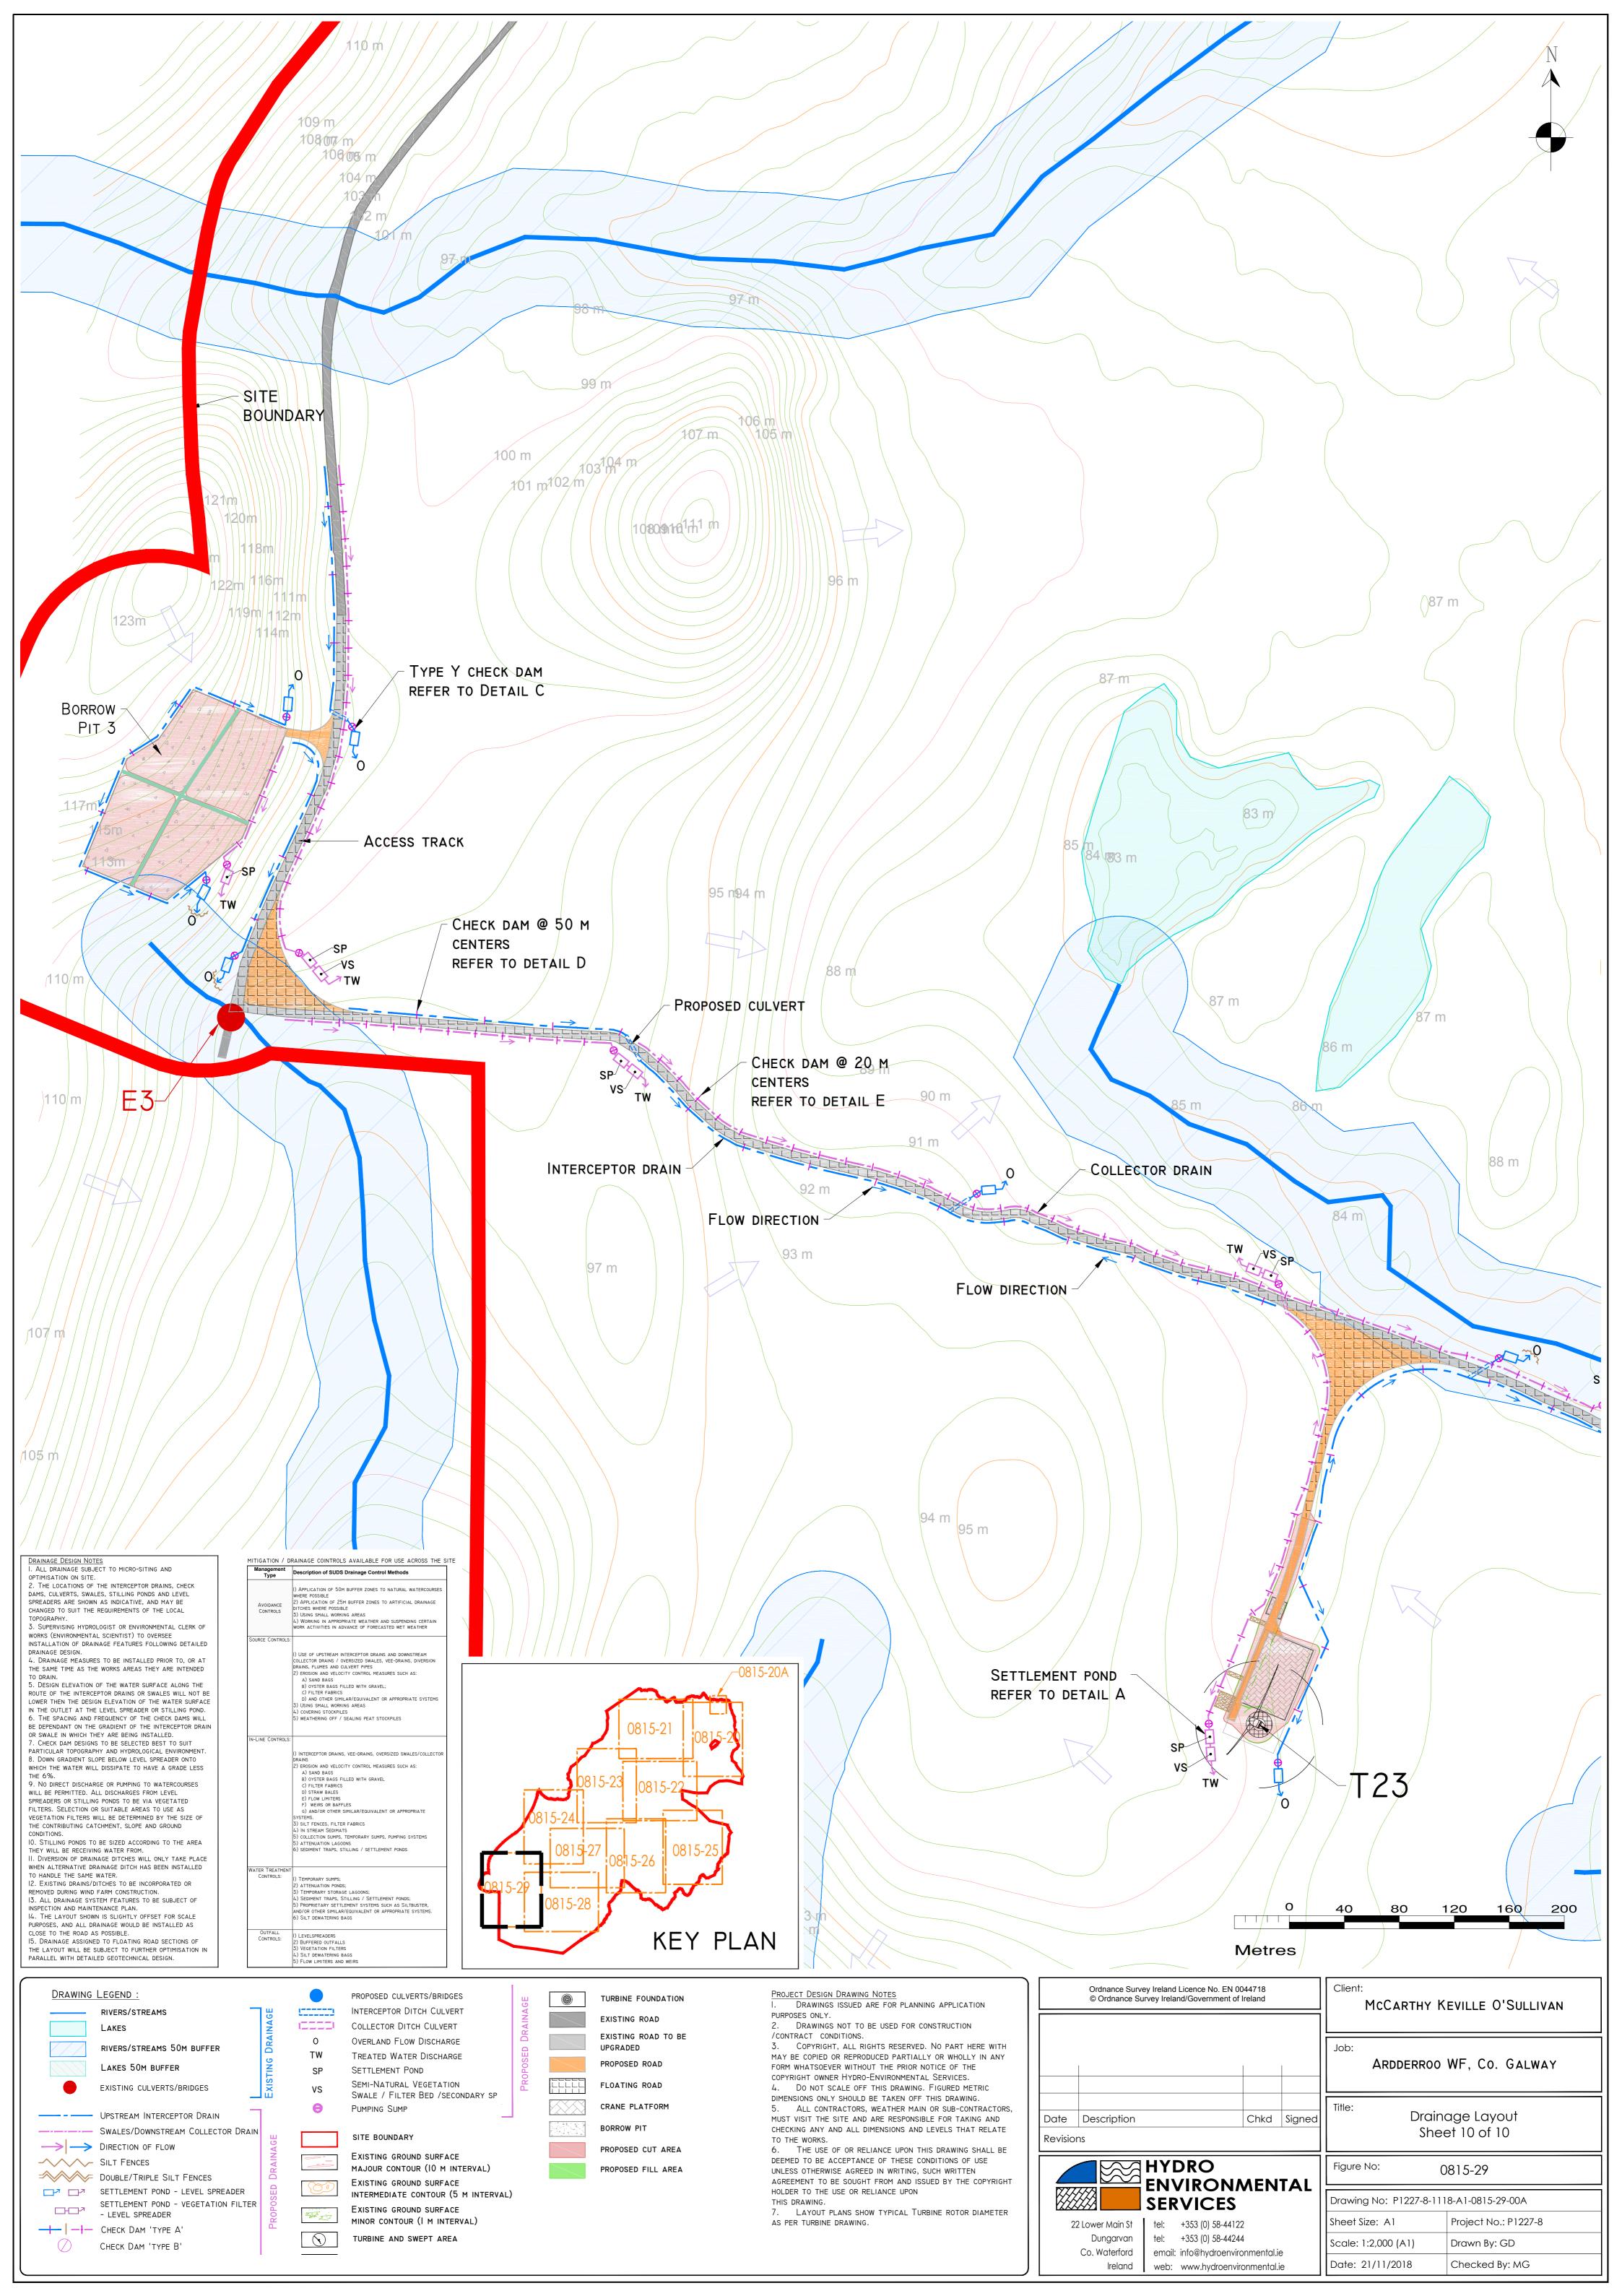

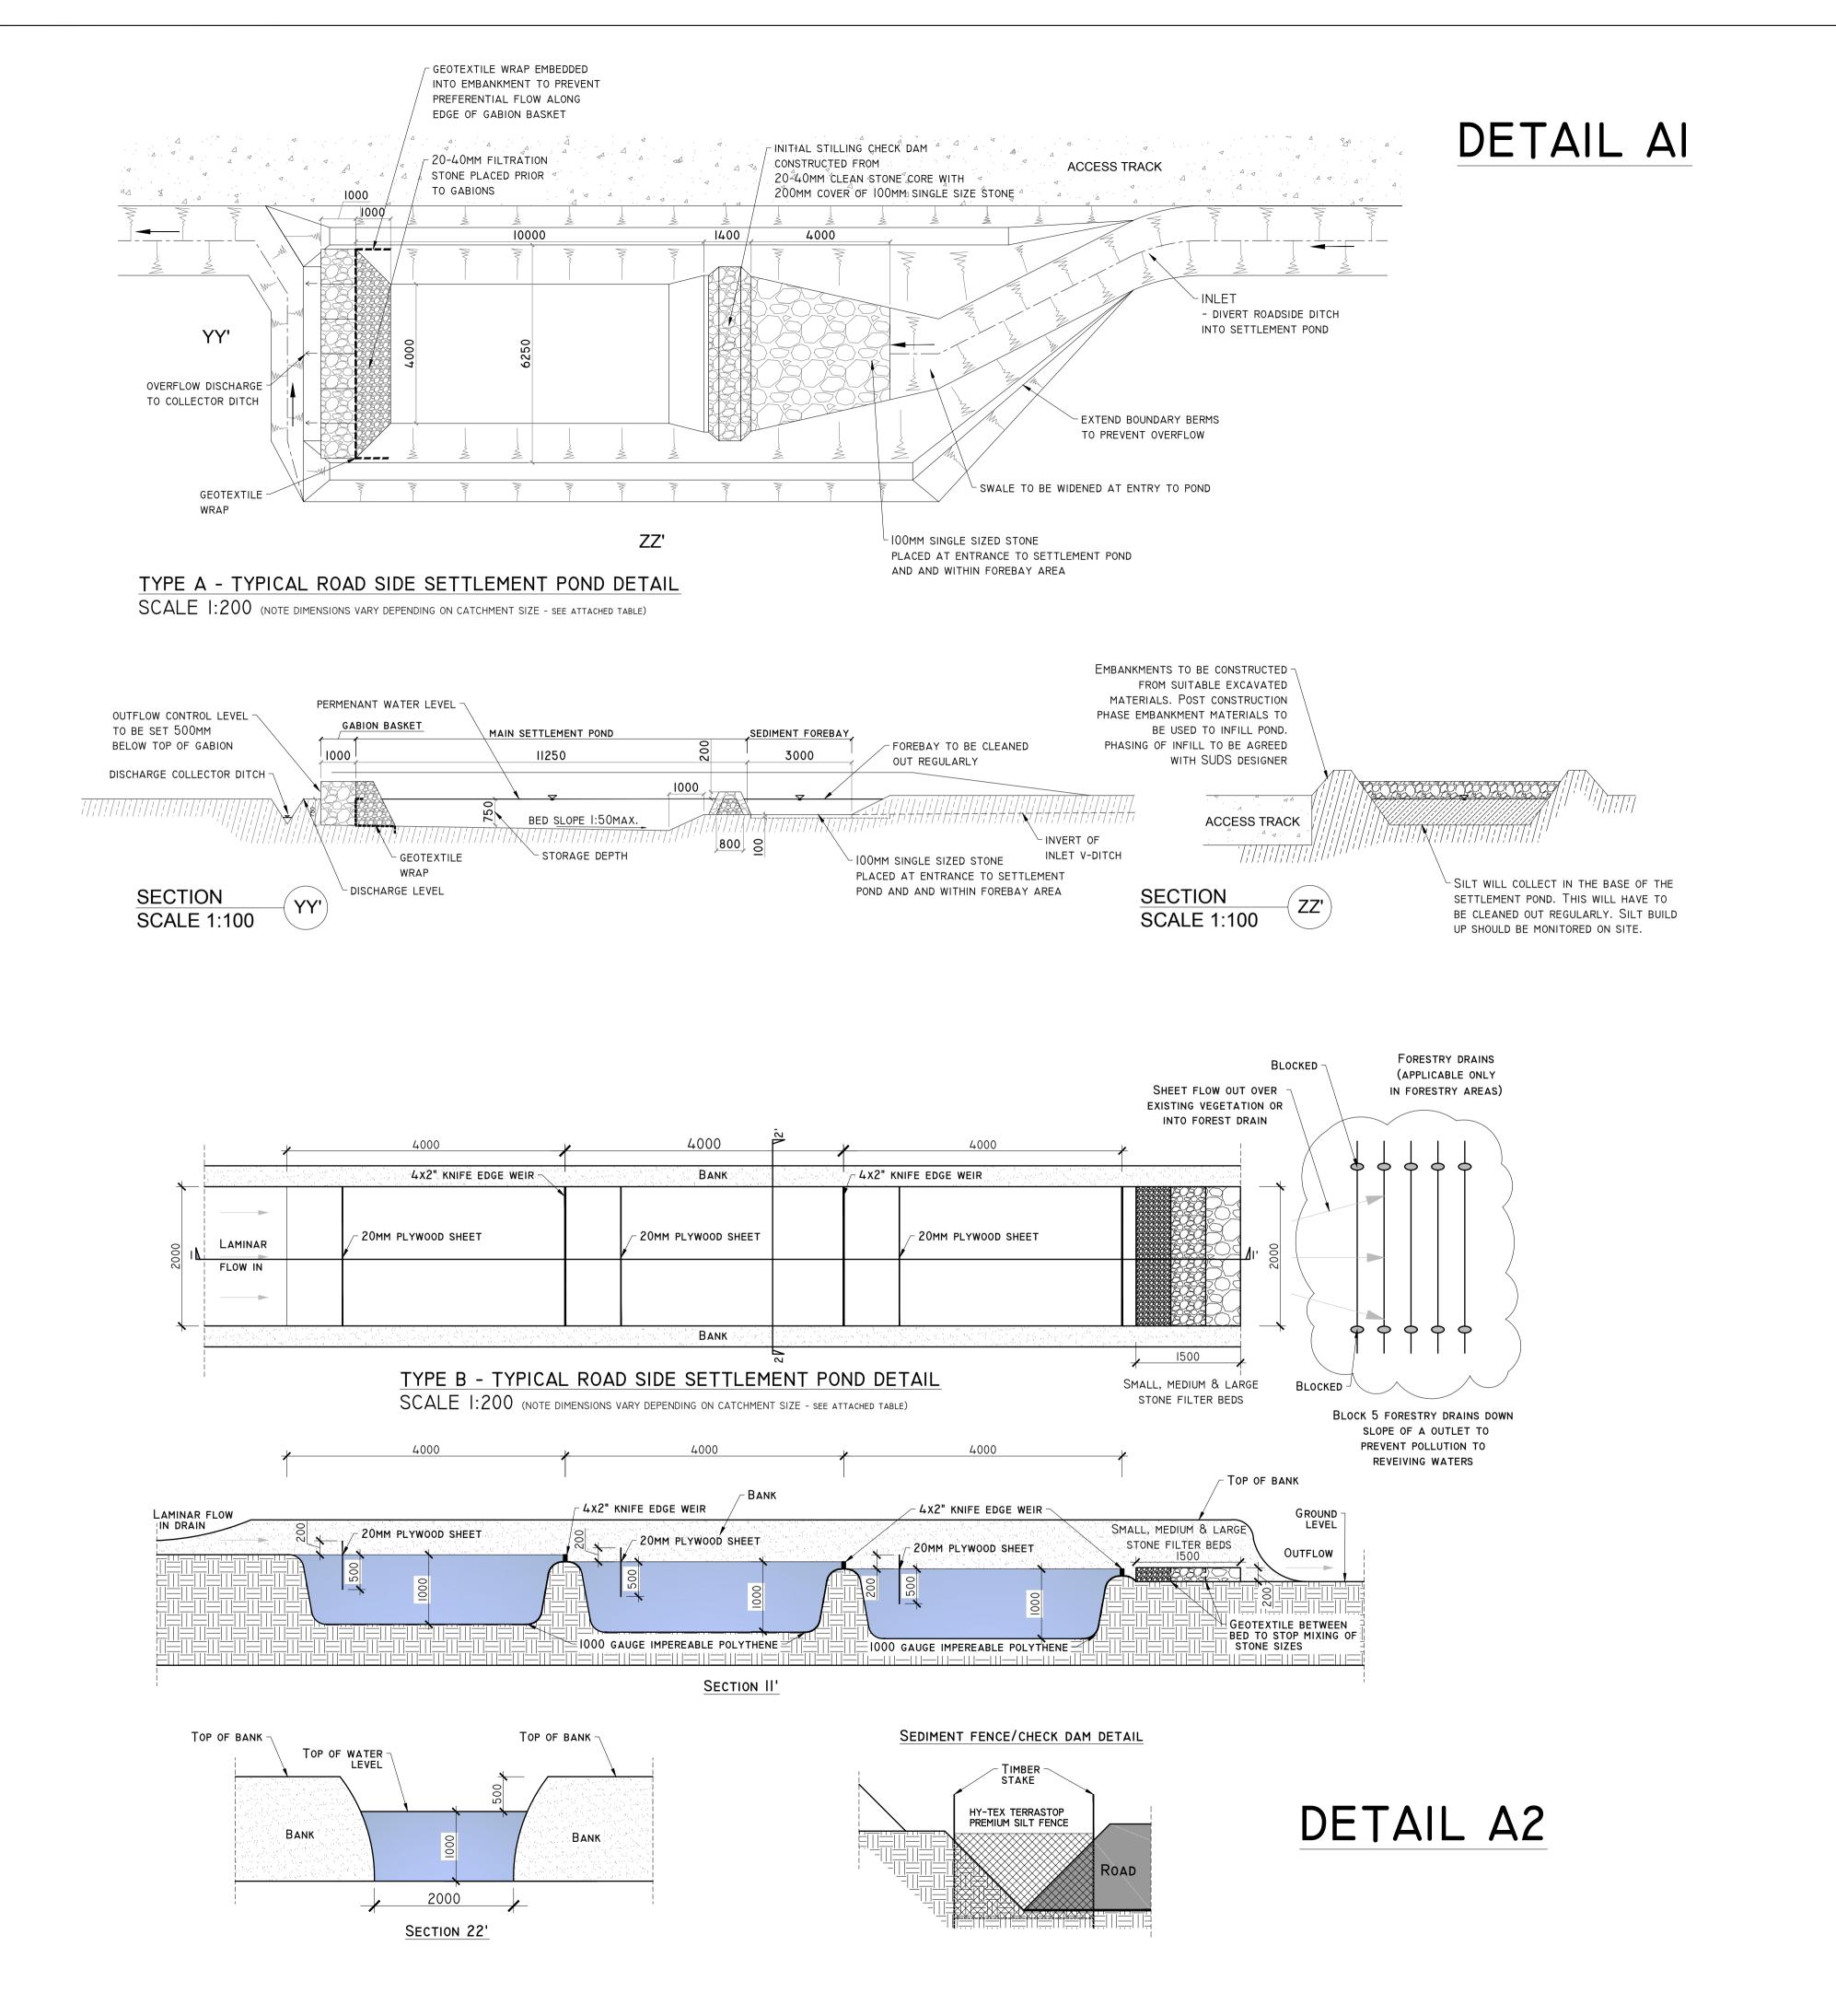

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Date Description Chkd Signed Revisions



22 Lower Main St tel: +353 (0) 58-44122 Dungarvan tel: +353 (0) 58-44244 Co. Waterford email: info@hydroenvironmental.ie Ireland web: www.hydroenvironmental.ie

Client: McCarthy Keville O'Sullivan

ARDDERROO WF, Co. GALWAY

Drainage Details 1


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### DETAIL B ROAD LEVEL


REFER TO CLIENT STANDARD DETAIL FOR ROAD MAKE UP OR FELLED FOREST LOGS SINGLE LAYER GEOSYNTHETIC — REINFORCEMENT / SEPARATION DRAINAGE PIPE IF REQUIRED

'TYPE A' CULVERT - DRAINAGE CROSSING BENEATH FLOATING ROAD




'TYPE B' CULVERT - DRAINAGE CROSSING BENEATH EXCAVATED ROAD SCALE I:50
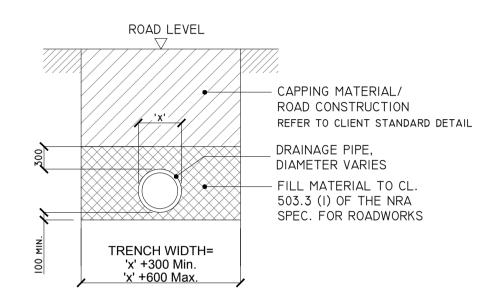
#### DETAIL BI

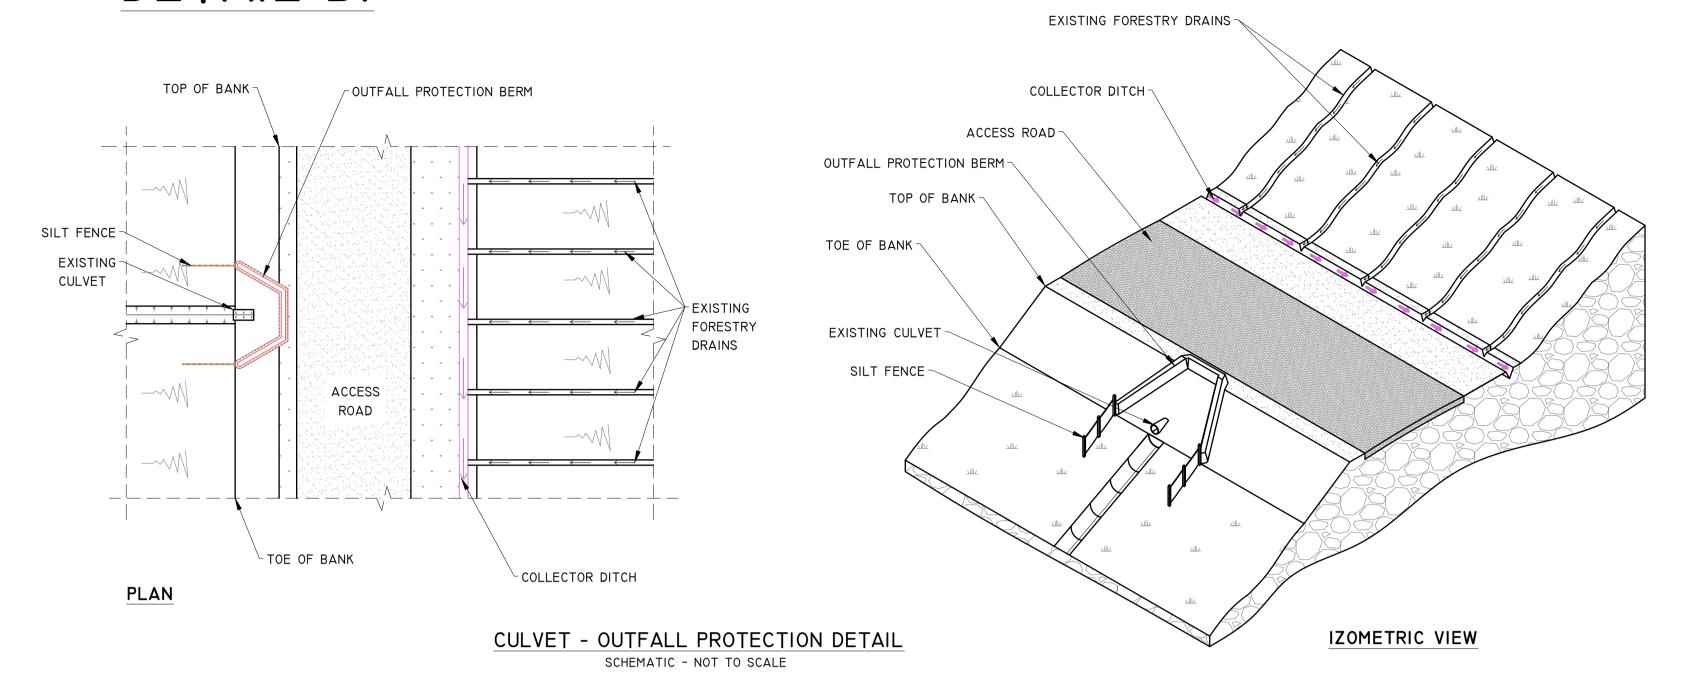



#### DETAIL C

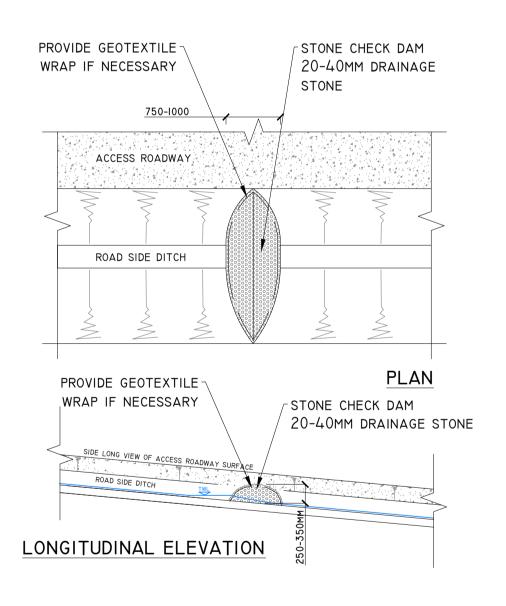


TYPE X - CHECK DAM DETAIL


#### DETAIL D

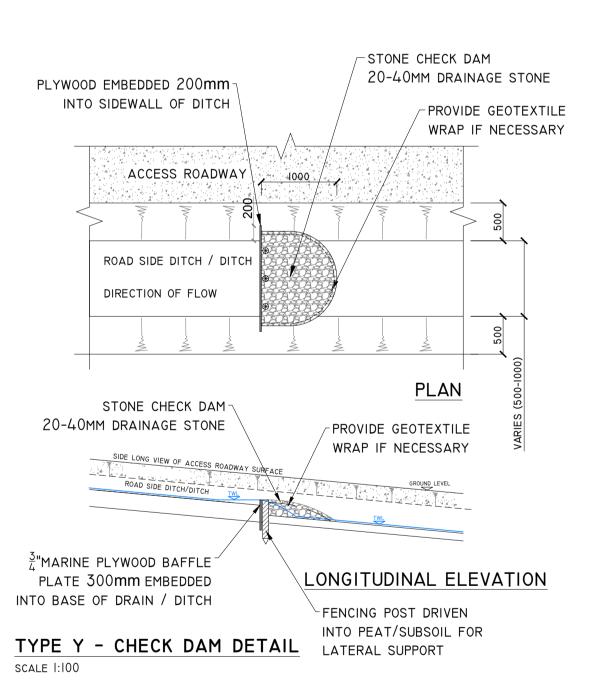

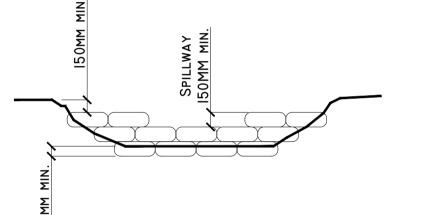

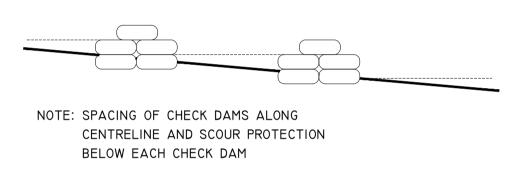

DETAIL CI

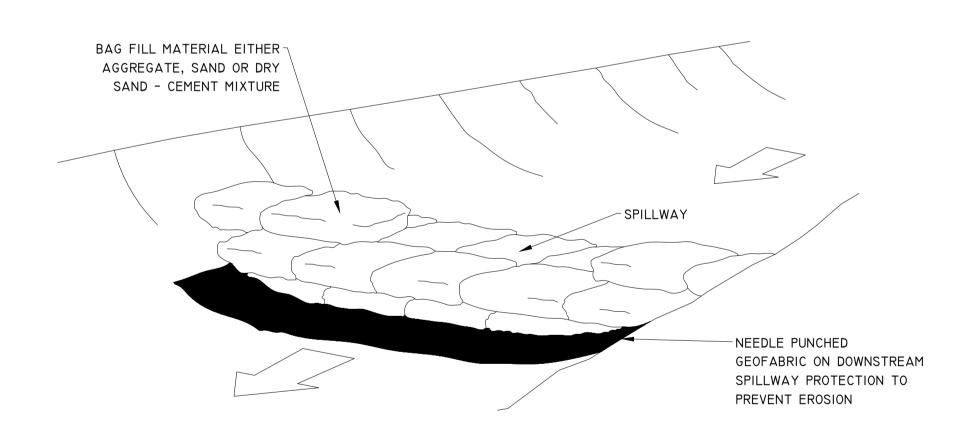

TEMPORARY CHECK DAM / SETTLEMENT POND OVERFLOW SAND FILLED BAG CONSTRUCTION SCHEMATIC - NOT TO SCALE

TEMPORARY CHECK DAM / SETTLEMENT POND OVERFLOW SCHEMATIC - NOT TO SCALE DETAIL C2 EROSION PROTECTION LENGTH SUCH THAT POINTS A AND B HAVE EQUAL ELEVATION **ELEVATION** 

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AND ARE RESPONSIBLE FOR TAKING AND CHECKING ANY AND ALL DIMENSIONS AND LEVELS THAT RELATE TO THE WORKS.

Chkd Signed Date Description



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Revisions

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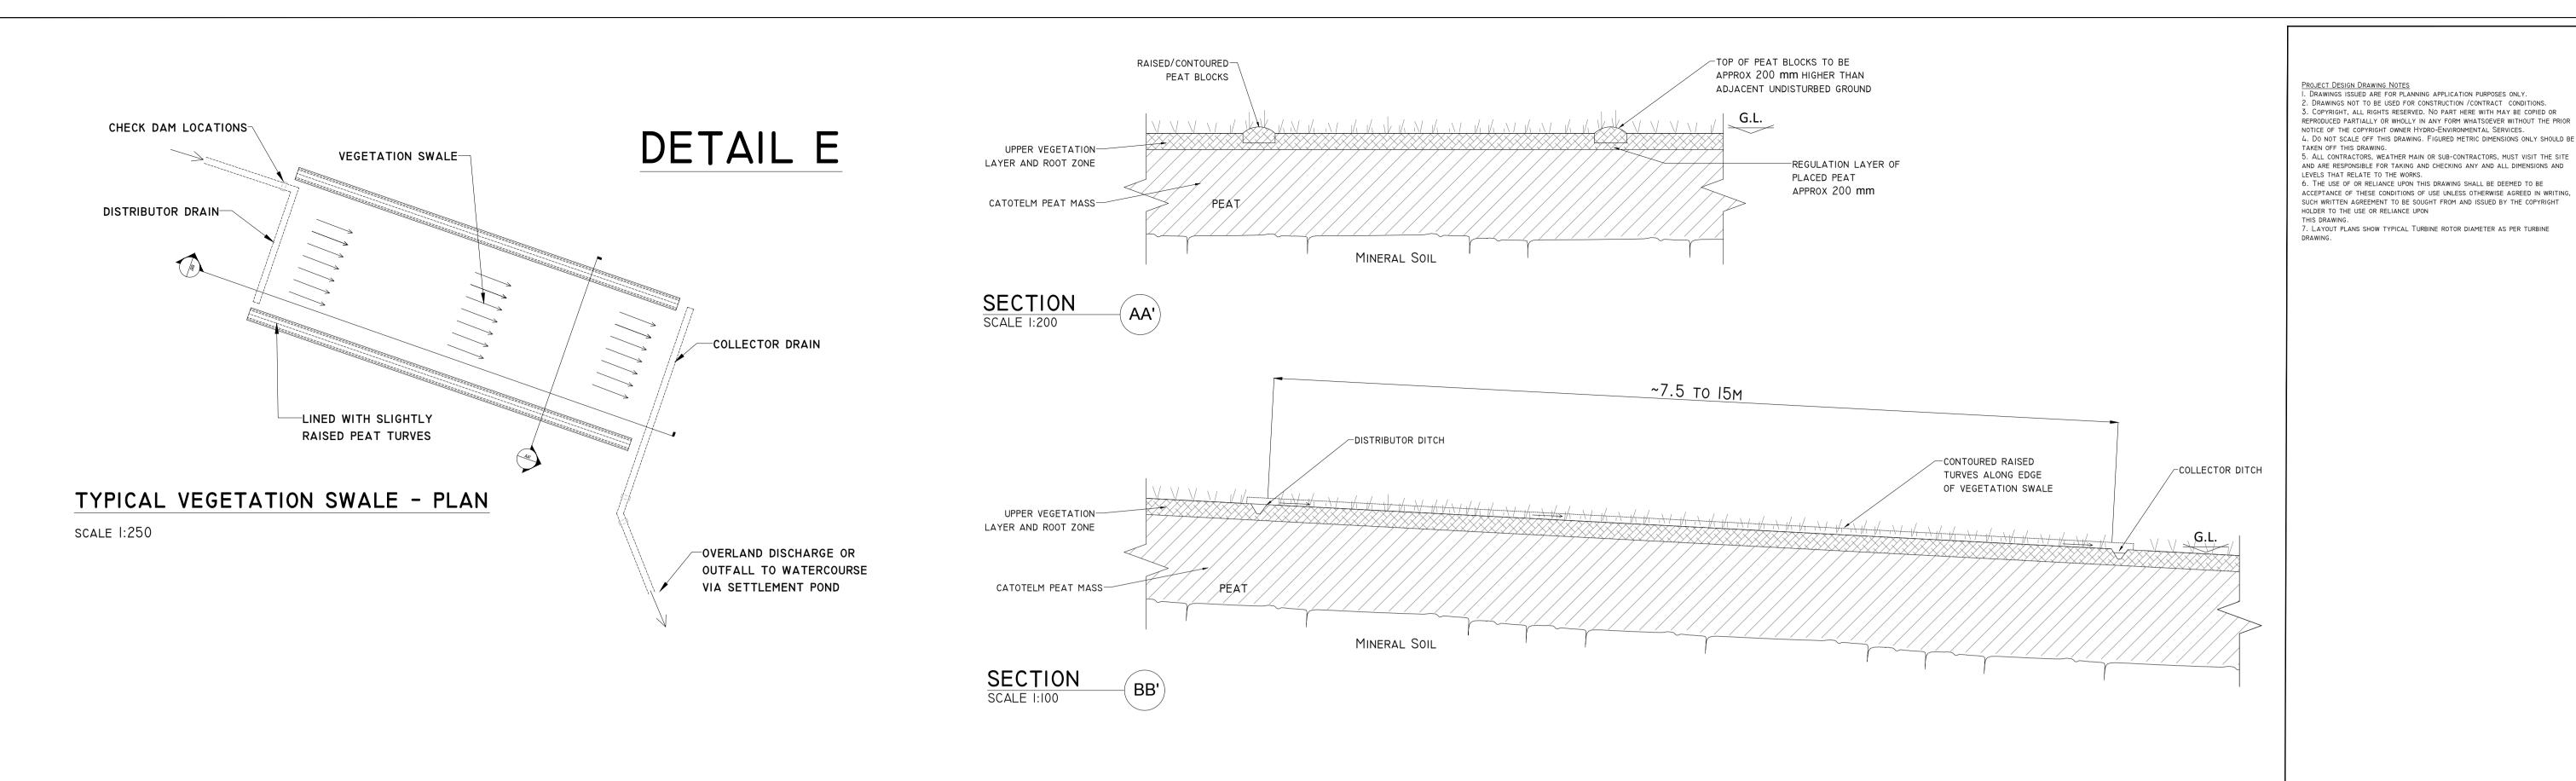
ARDDERROO WF, Co. GALWAY


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Drainage Details 2


0815-31






SILT FENCE FOR WATERCOURSE PROTECTION SCALE 1:25
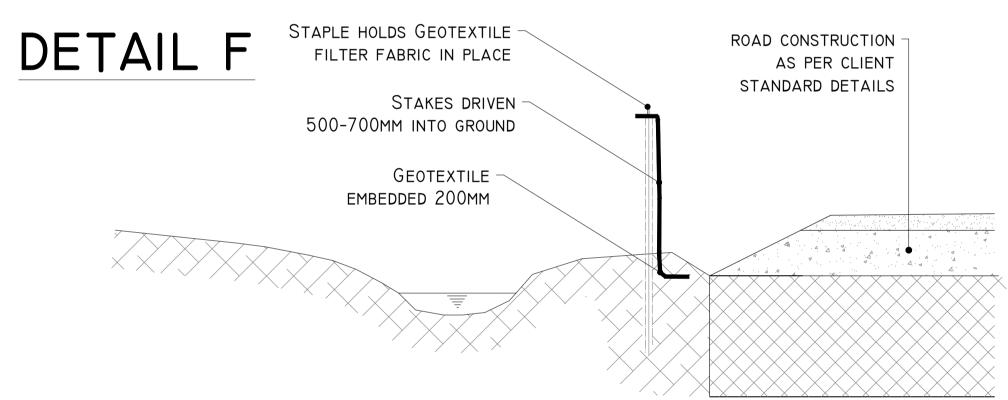
## DETAIL G-I MATERIAL STOCKPILE

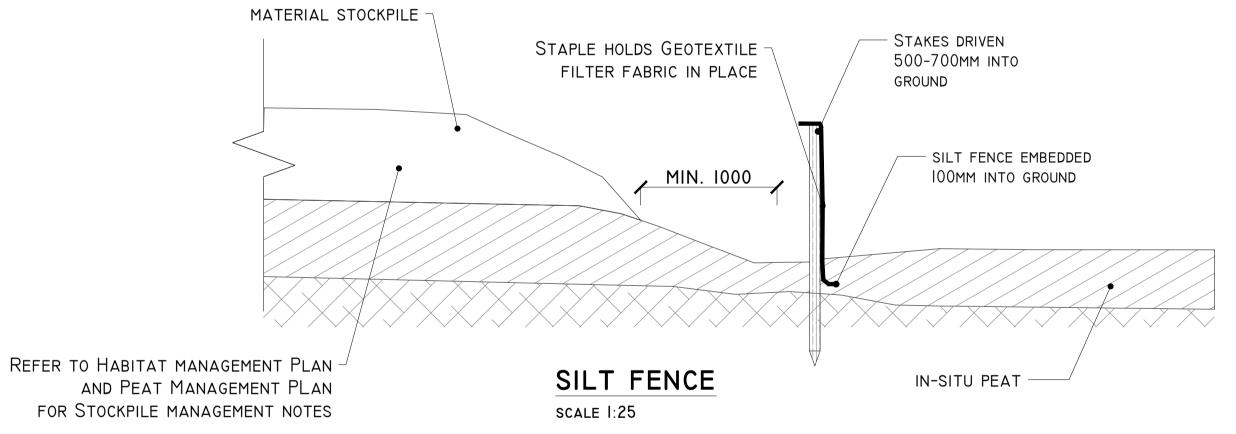

DETAIL G-II

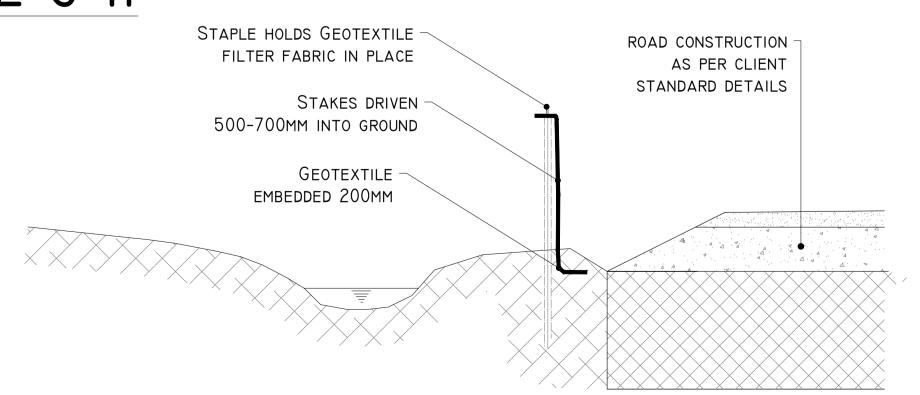

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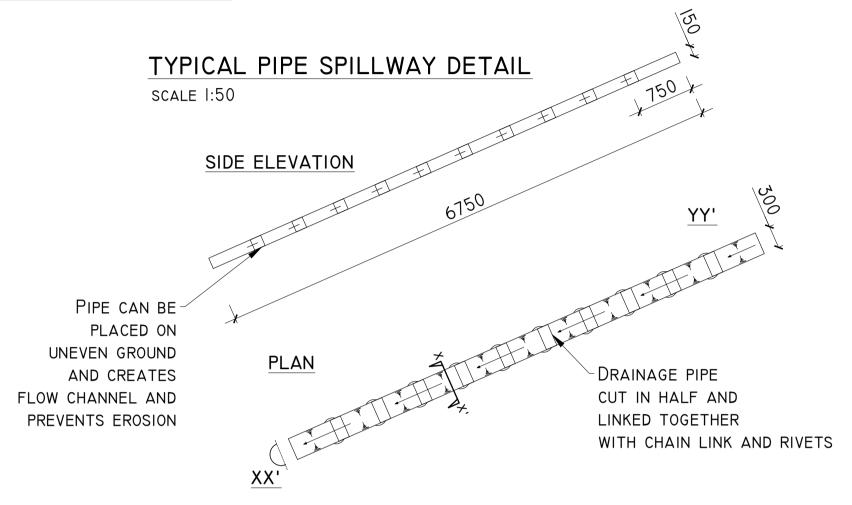
ARDDERROO WF, Co. GALWAY


Drainage Details 3


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#### DETAIL H






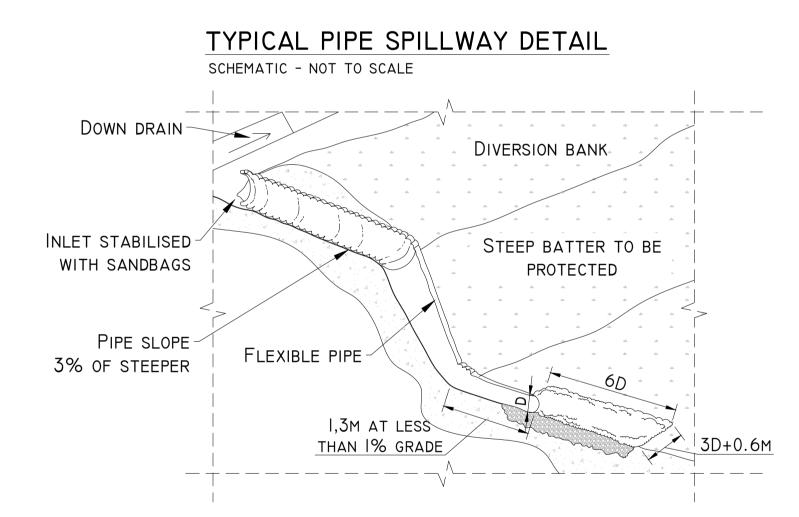

#### TEMPORARY CONCRETE WASH OUT PIT

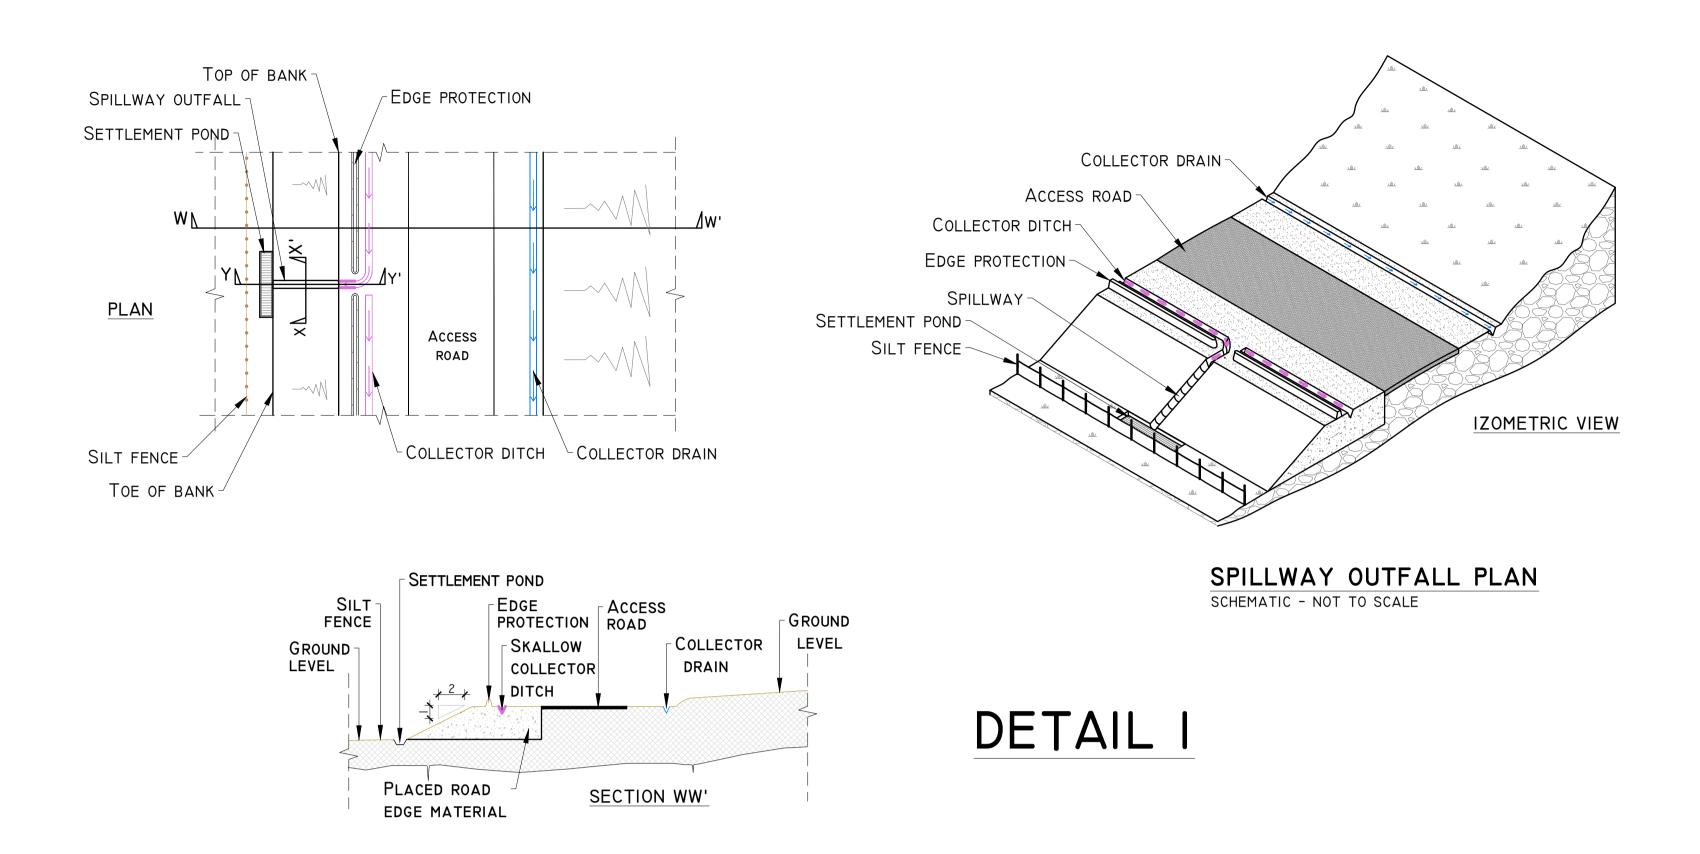PLAN <sup>\</sup>STOP LOG

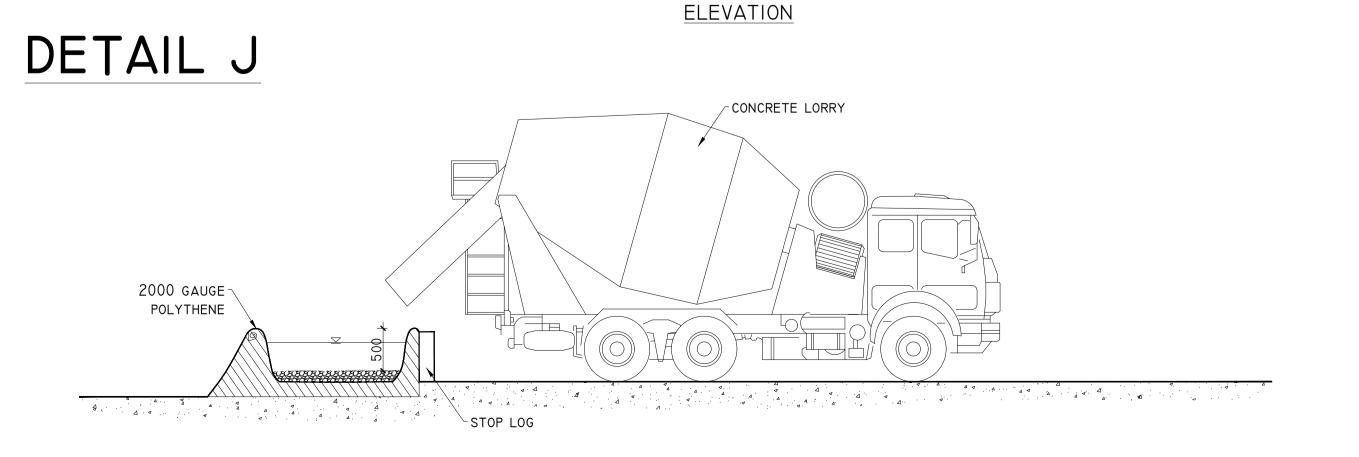

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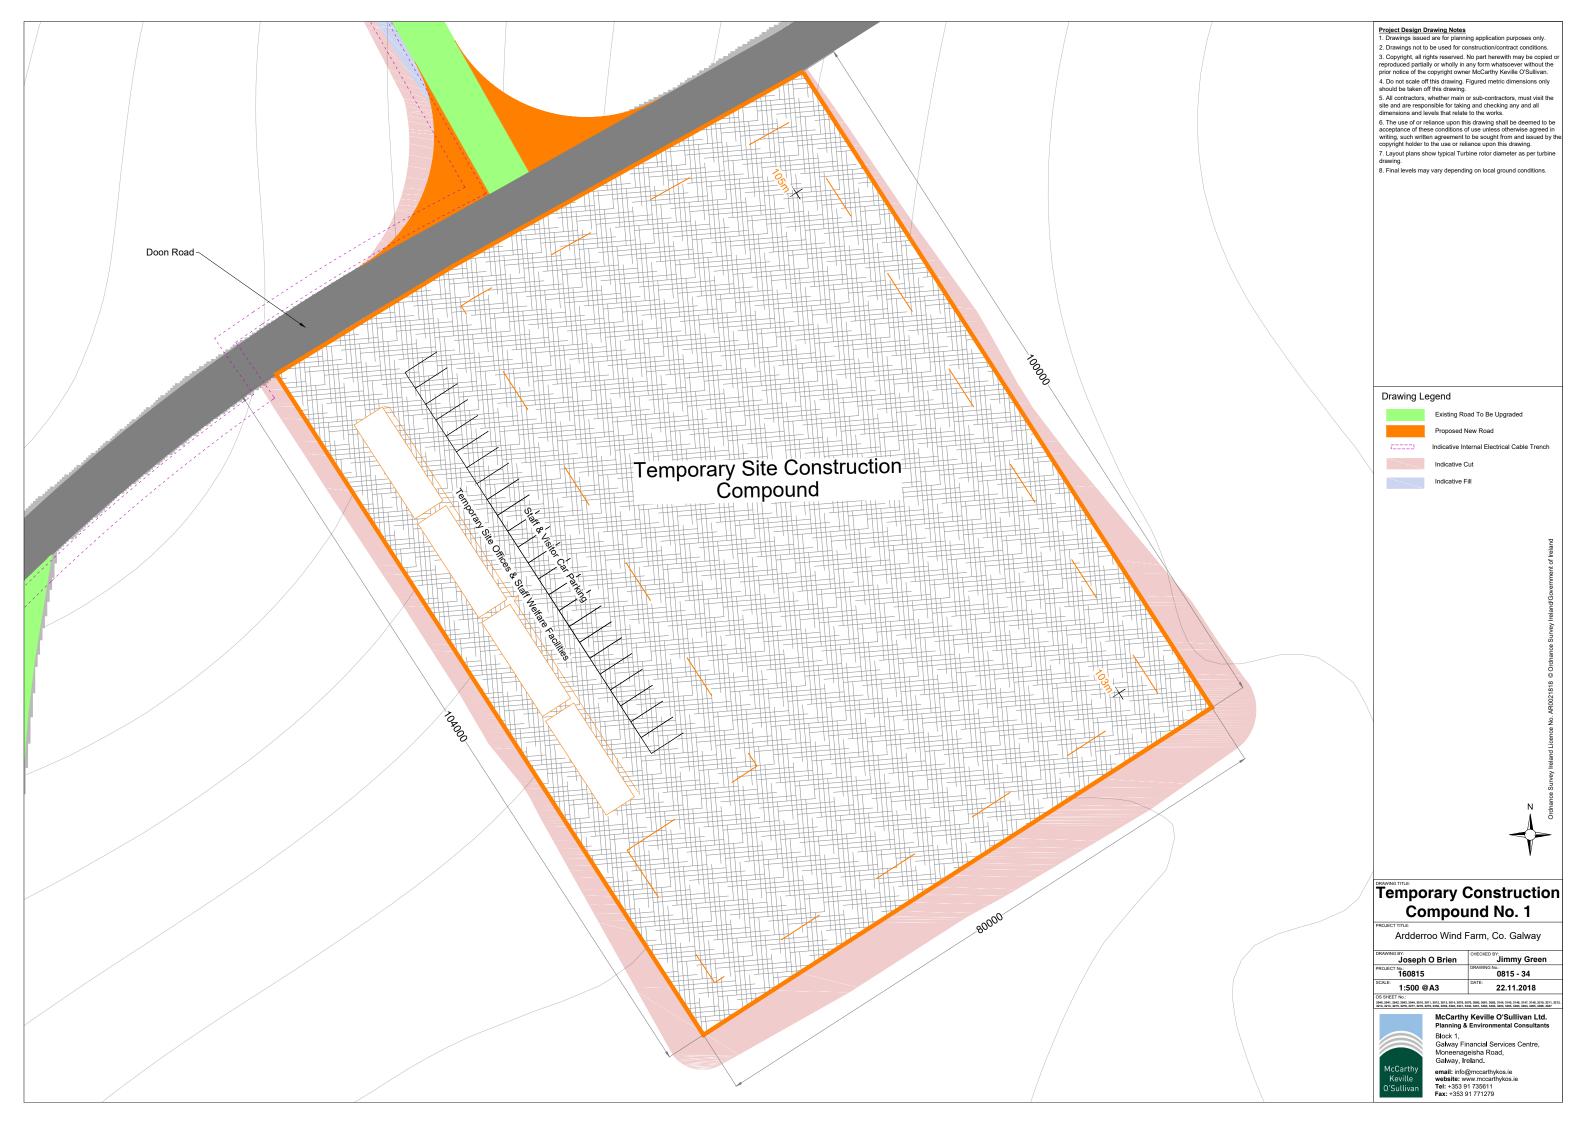
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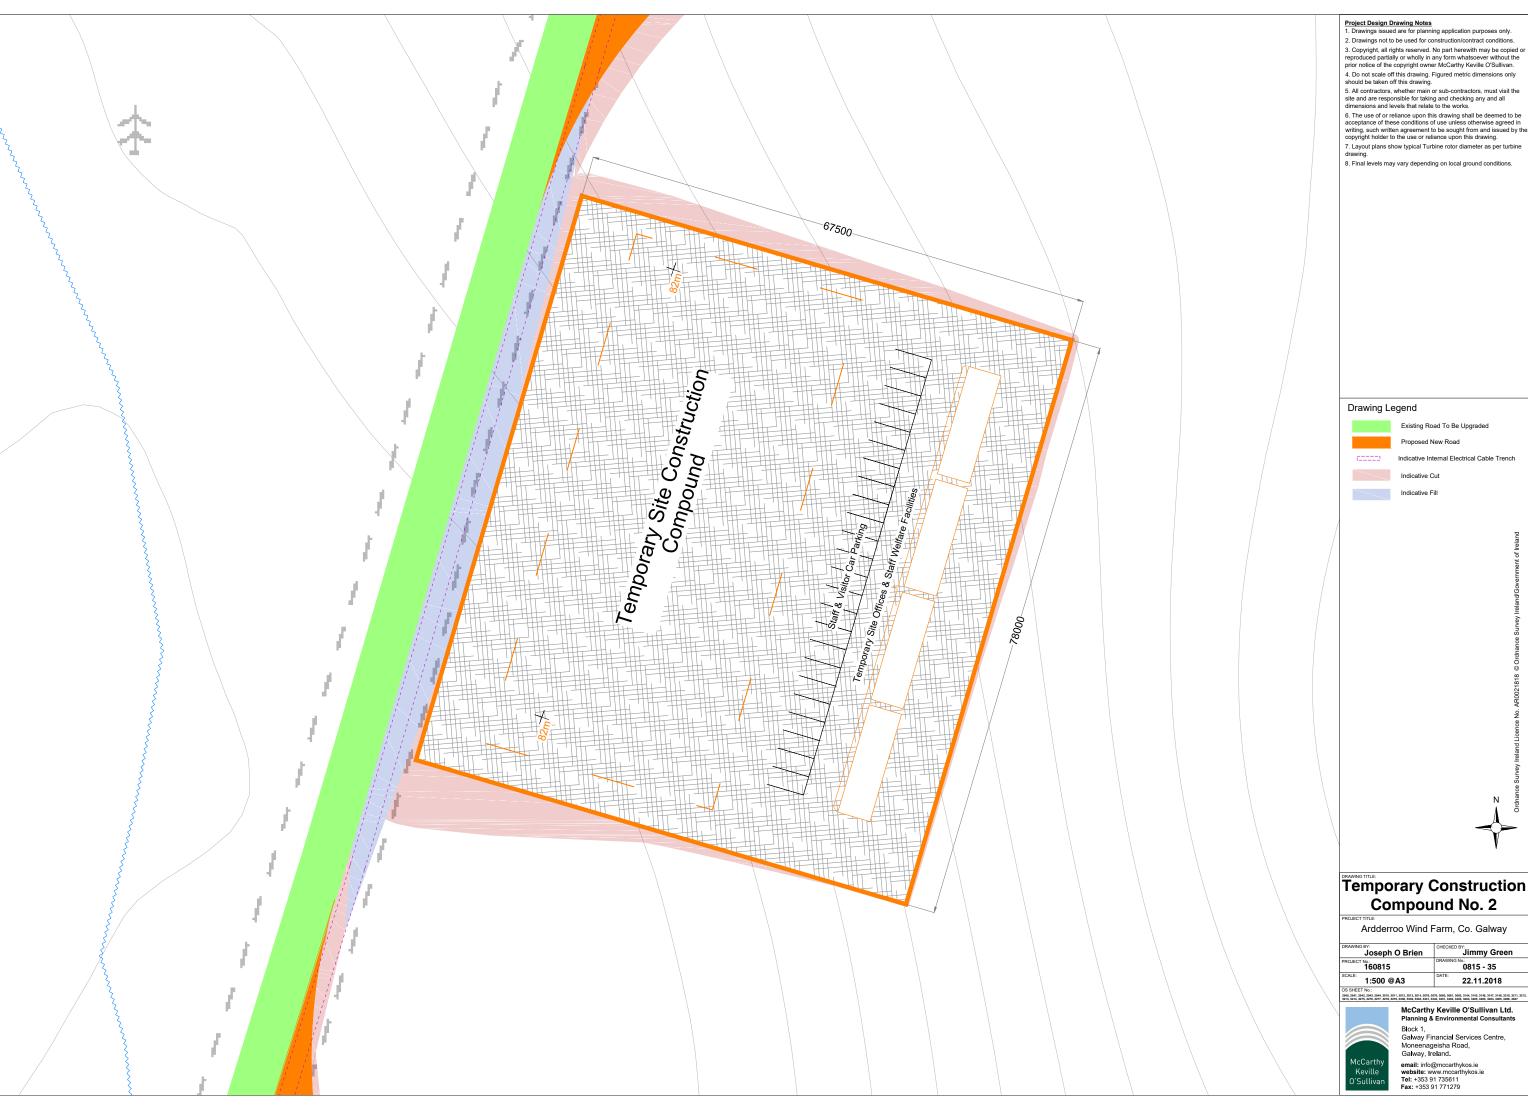
ARDDERROO WF, Co. GALWAY

Drainage Details 4

Figure No: 0815-33

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#### Drawing Legend

Existing Road To Be Upgraded


#### Temporary Construction Compound No. 2


Ardderroo Wind Farm, Co. Galway


Jimmy Green
0815 - 35
22.11.2018





McCarthy Keville O'Sullivan Ltd.
Planning & Environmental Consultants Block 1, Galway Financial Services Centre Moneenageisha Road, Galway, Ireland.

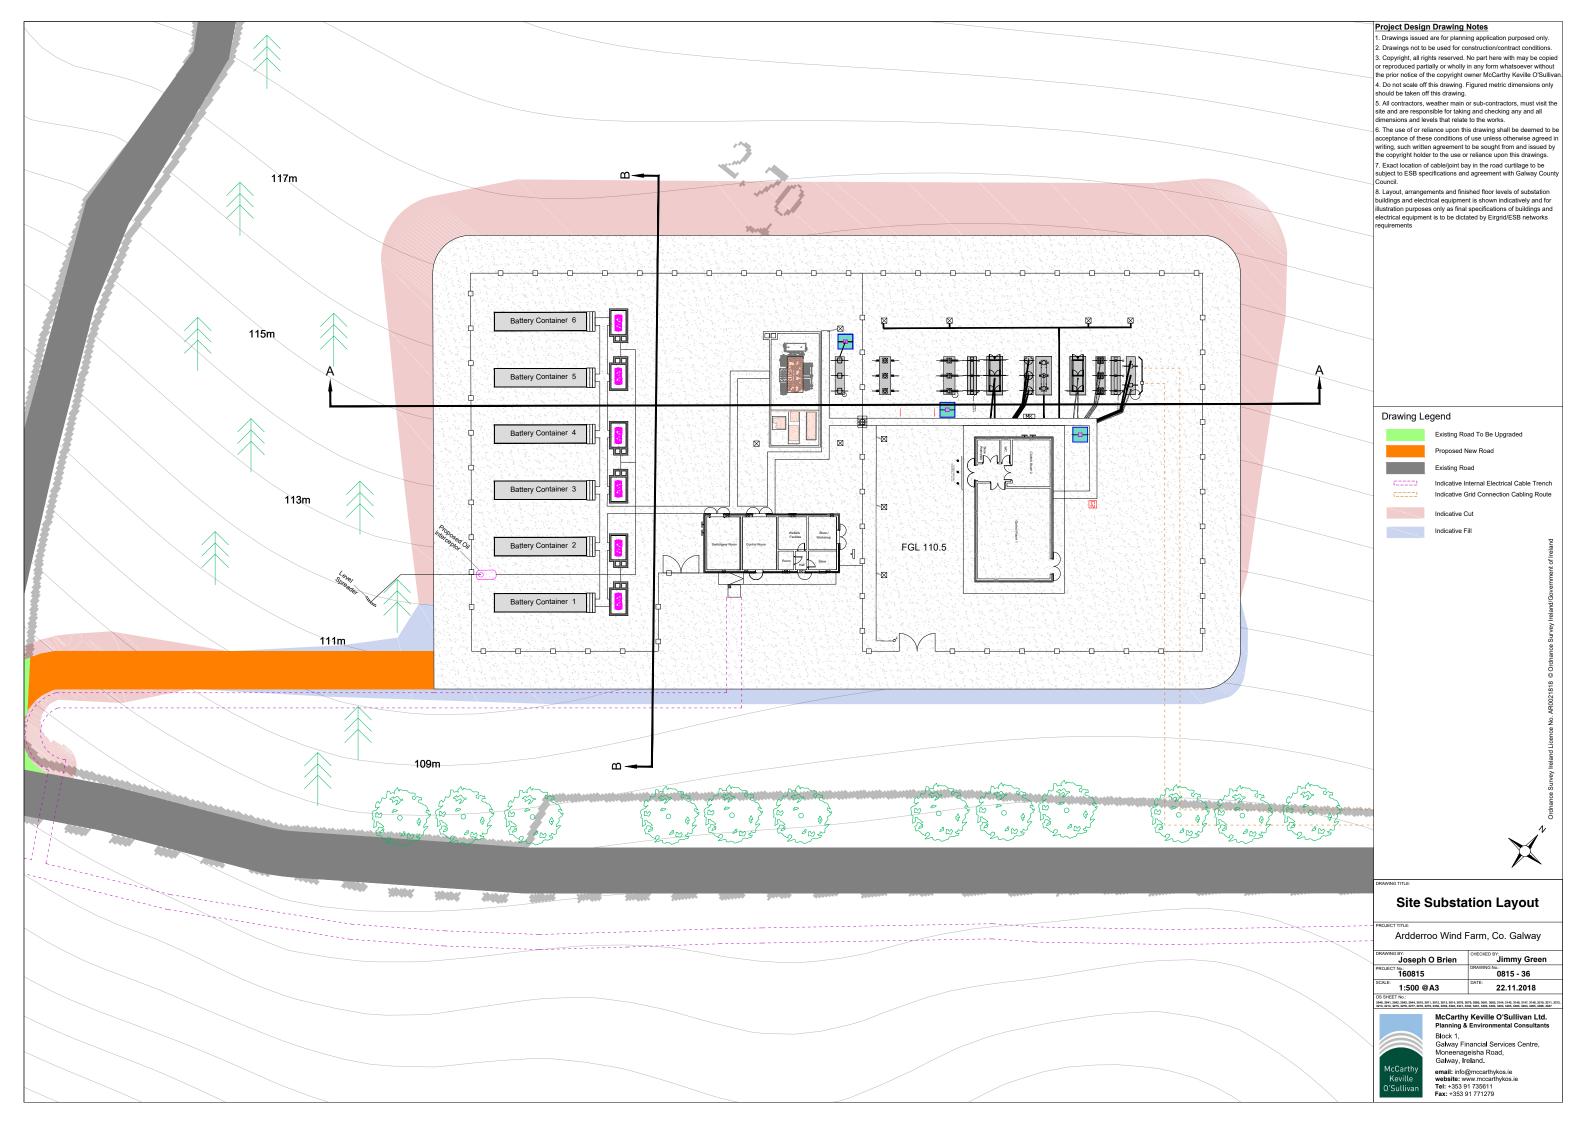

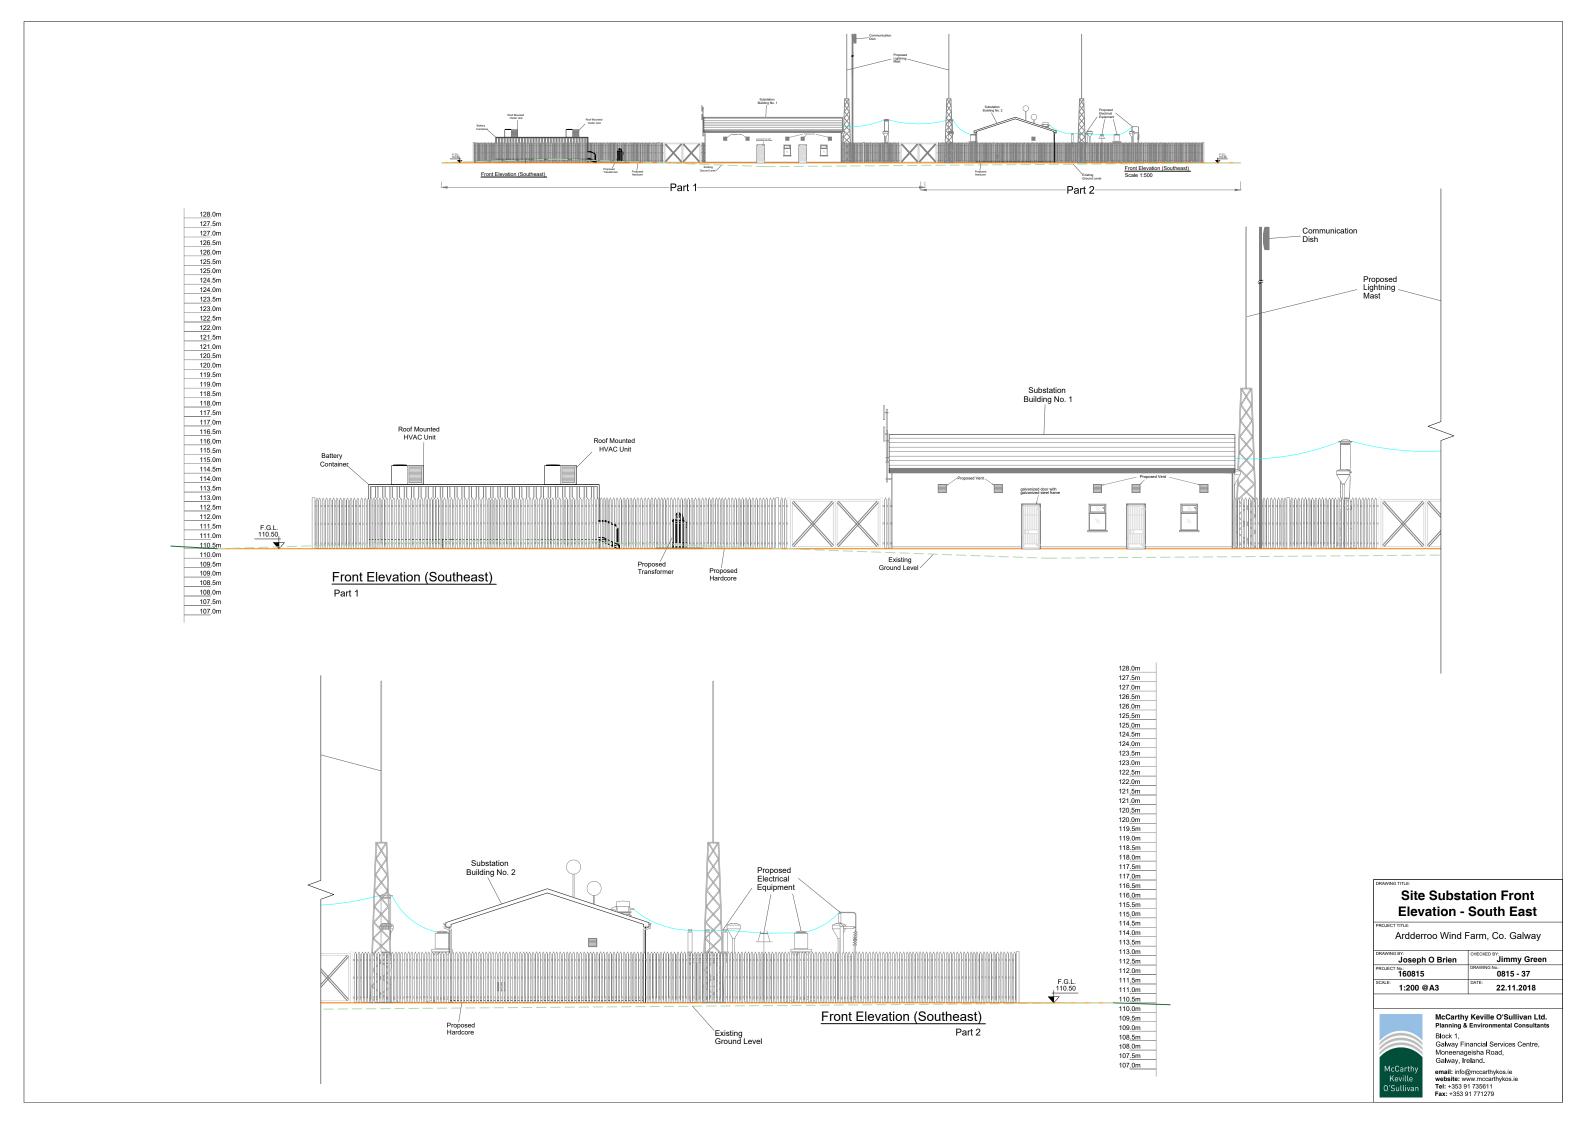

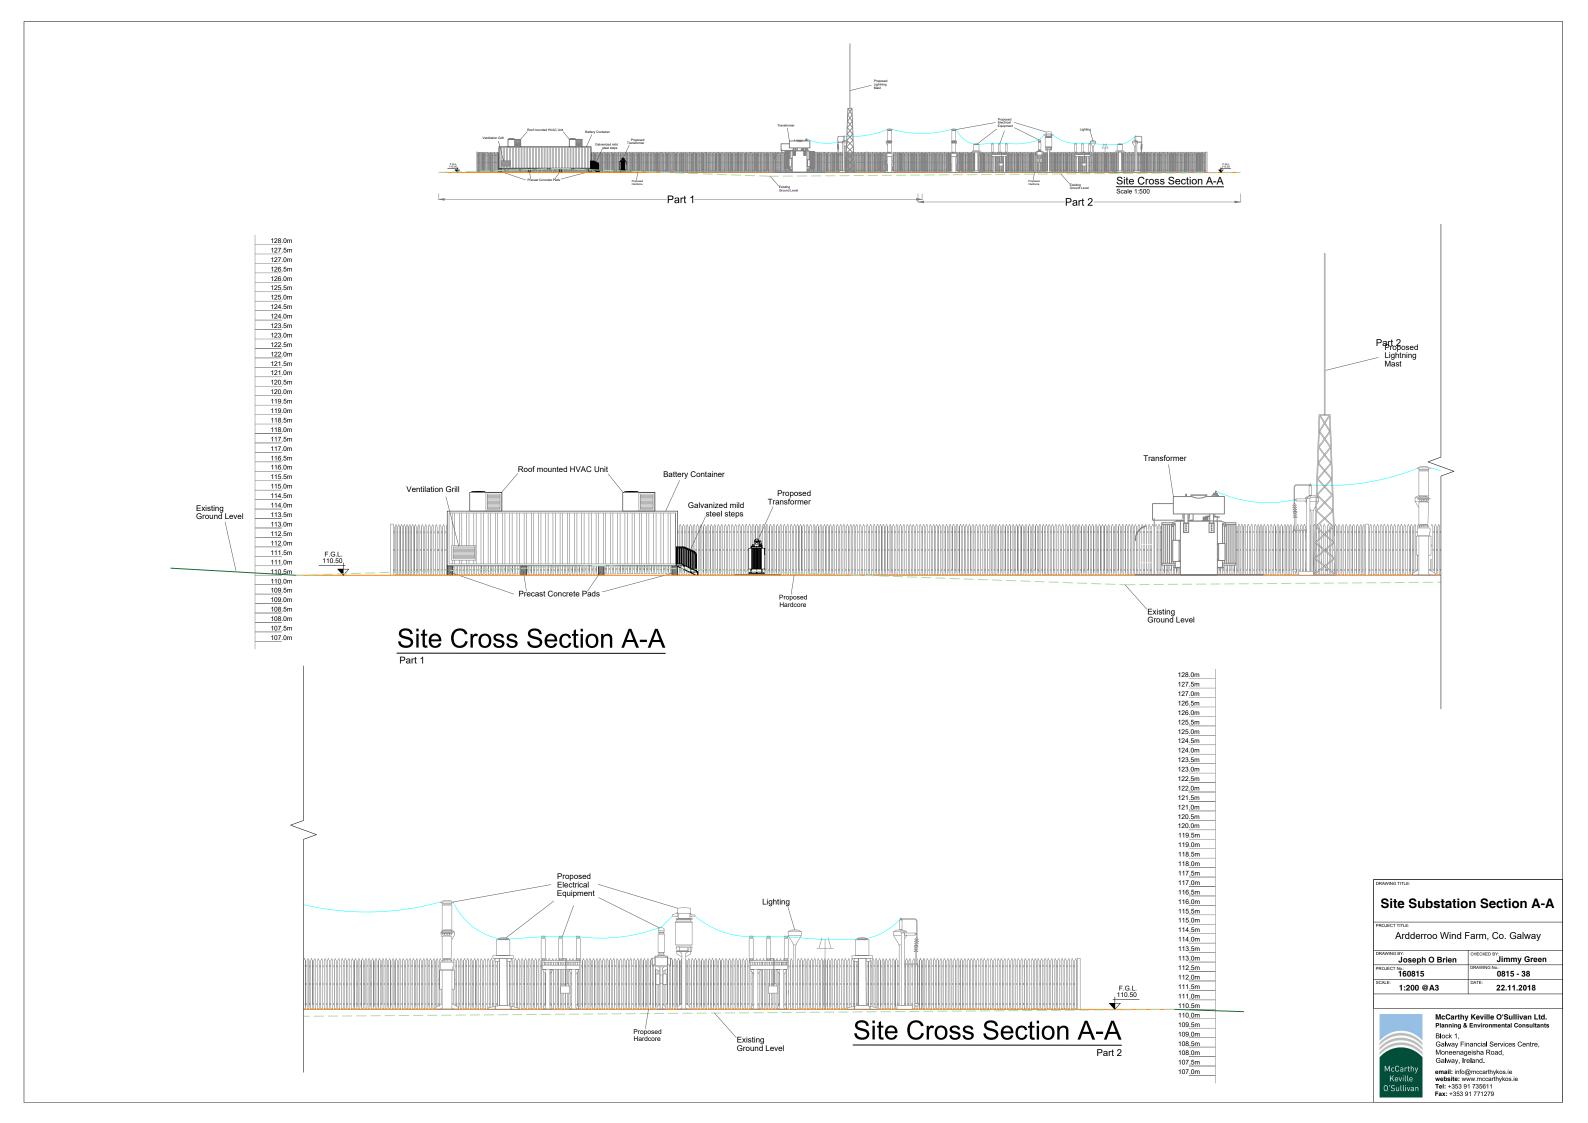

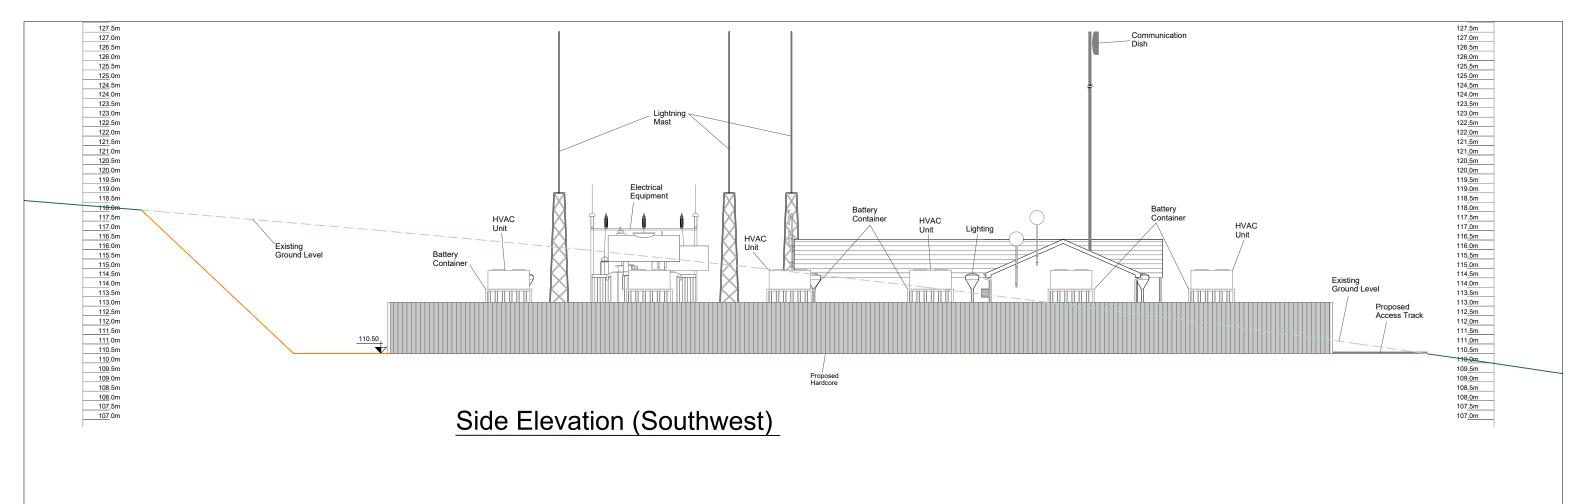

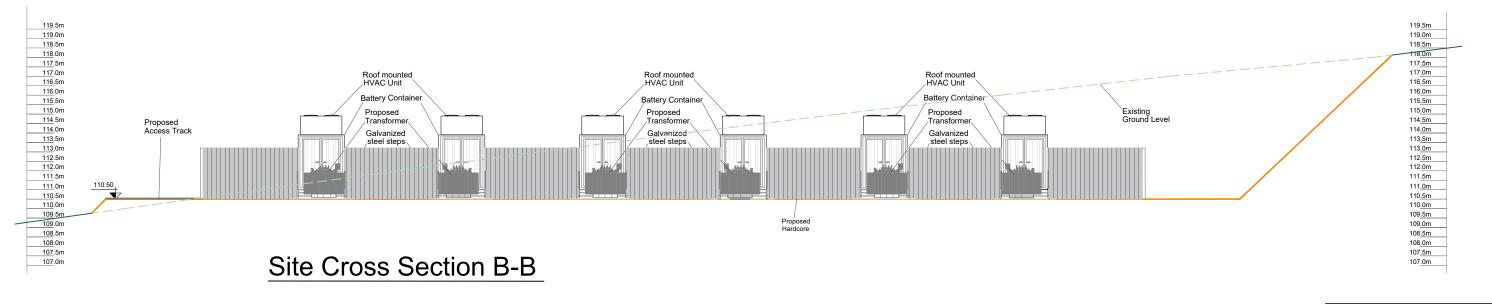

#### AWING TITLE:

## Site Substation Side Elevation - South West & Section


Ardderroo Wind Farm, Co. Galway

Joseph O Brien	Jimmy Green
PROJECT No.: 160815	0815 - 39
1:200 @A3	22.11.2018



McCarthy Keville O'Sullivan Ltd.
Planning & Environmental Consultants
Block 1,
Galway Financial Services Centre

Block 1, Galway Financial Services Centre, Moneenageisha Road, Galway, Ireland. email: info@mccarthykos.ie website: www.mccarthykos.ie Tel: +353 91 735611 Fax: +353 91 771279

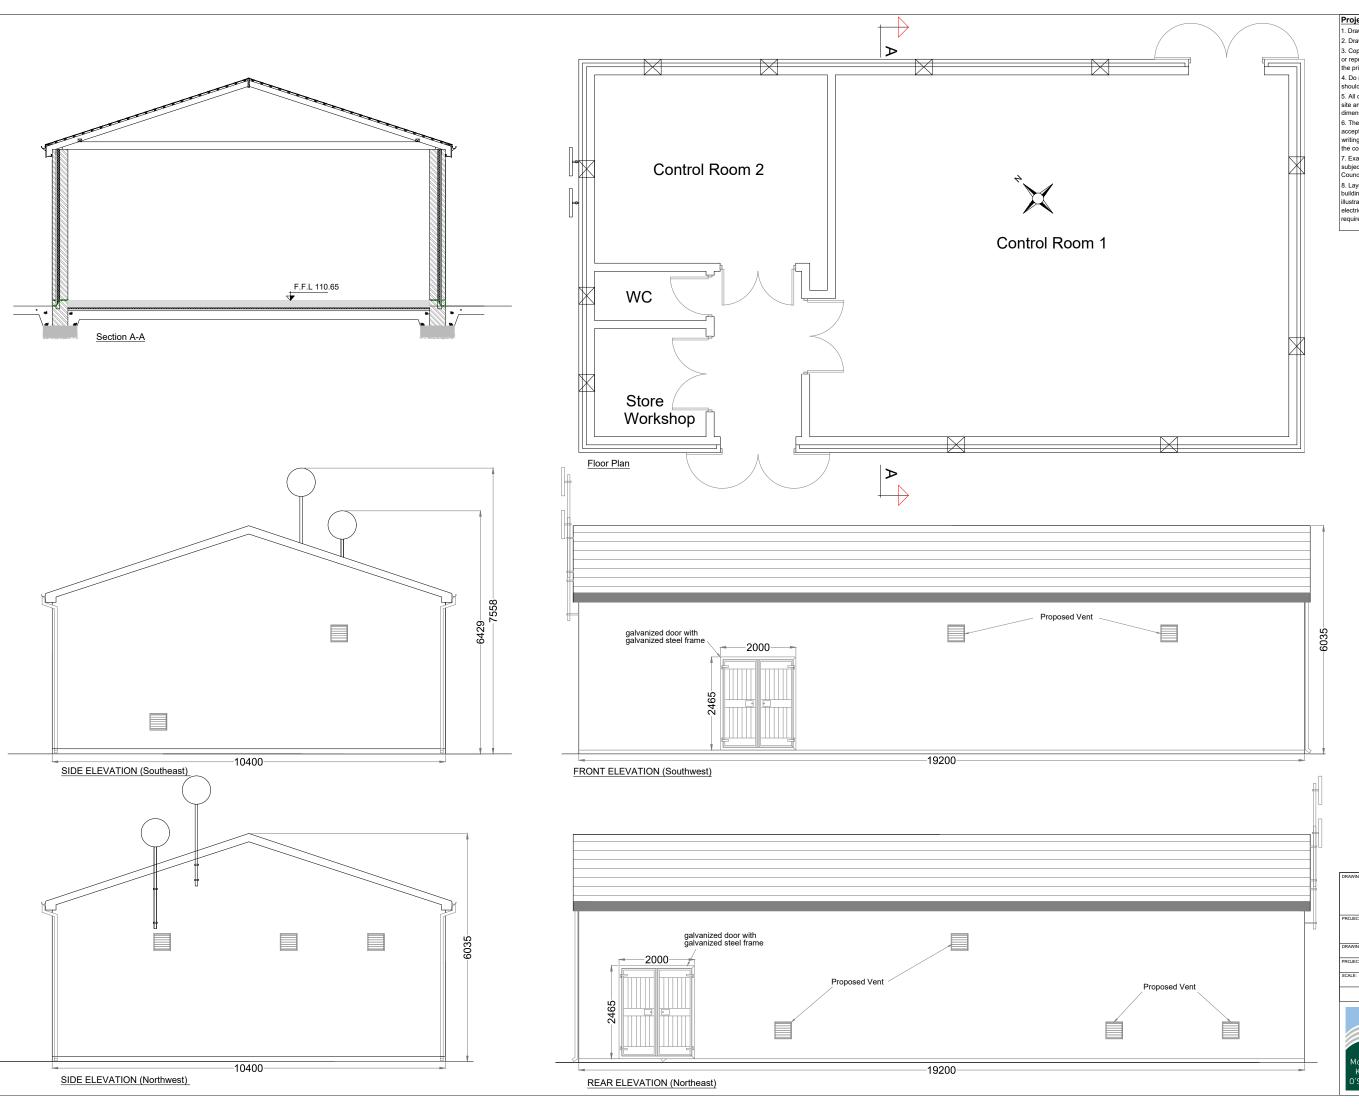

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    7. Exact location of cable/joint bay in the road curtilage to be subject to ESB specifications and agreement with Galway County Council.

Solution.

8. Layout, arrangements and finished floor levels of substation buildings and electrical equipment is shown indicatively and for illustration purposes only as final specifications of buildings and electrical equipment is to be dictated by Eirgrid/ESB networks

#### **Control Building 1 Elevations & Section**


Ardderroo Wind Farm, Co. Galway

Joseph O Brien	Jimmy Green
PROJECT No.: 160815	0815 - 40
1:100 @A3	22.11.2018



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- dimensions and levels that relate to the works.

  6. The use of or reliance upon this drawing shall be deemed to be acceptance of these conditions of use unless otherwise agreed in writing, such written agreement to be sought from and issued by the copyright holder to the use or reliance upon this drawings.

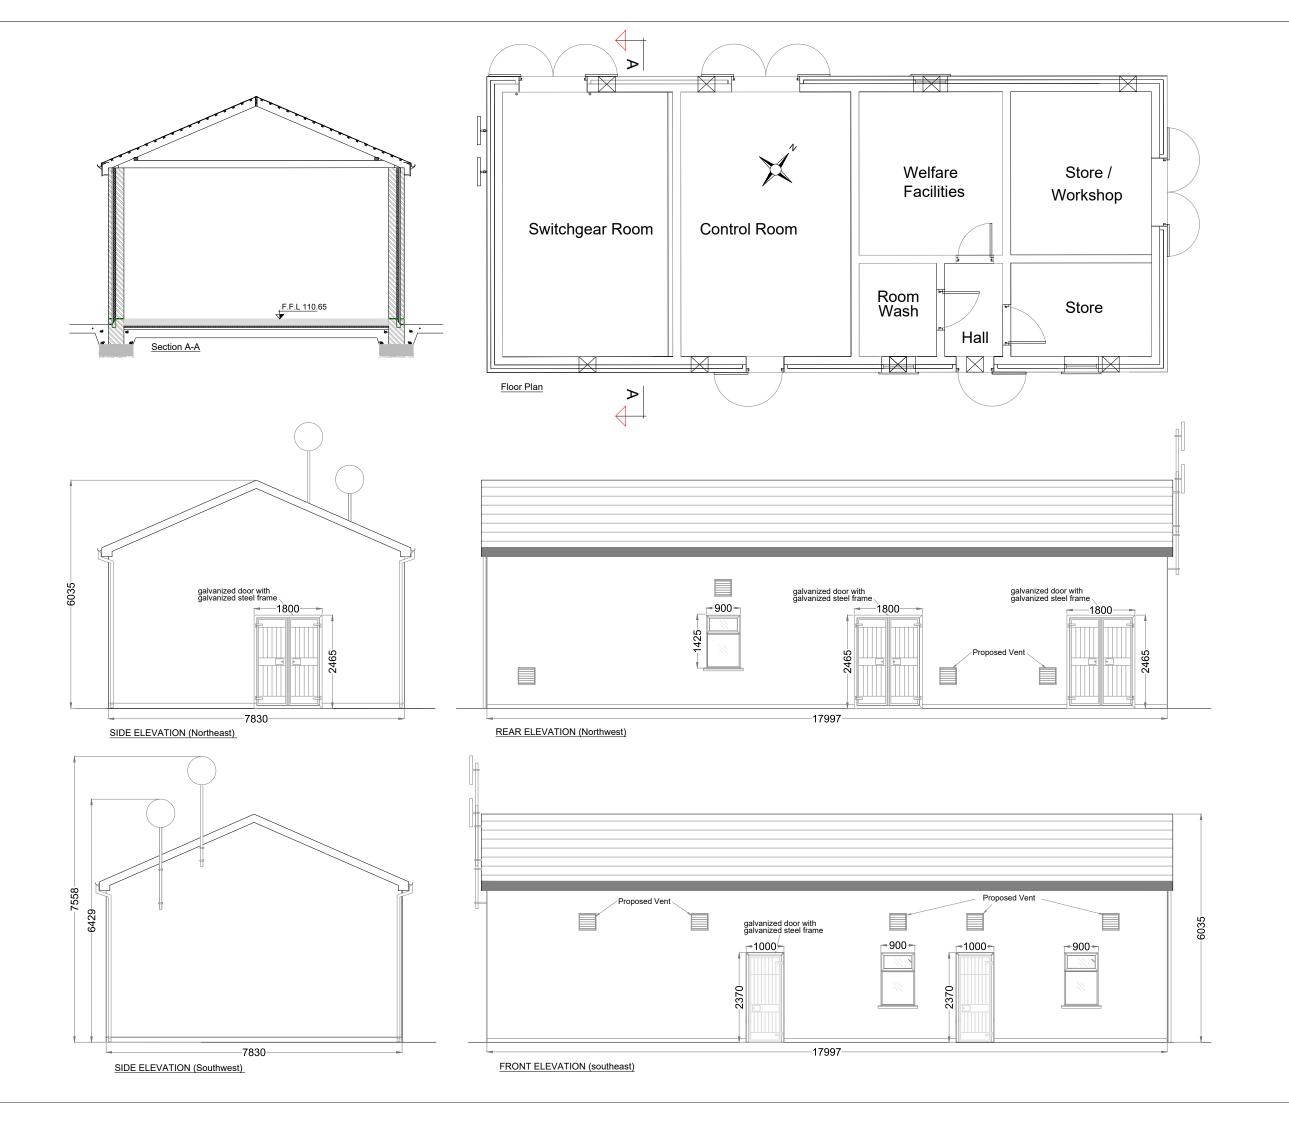  7. Exact location of cable/joint bay in the road curtilage to be subject to ESB specifications and agreement with Galway County Council.
- Solution.

  8. Layout, arrangements and finished floor levels of substation buildings and electrical equipment is shown indicatively and for illustration purposes only as final specifications of buildings and electrical equipment is to be dictated by Eirgrid/ESB networks

## **Control Building 2**

#### **Elevations & Section**

Ardderroo Wind Farm, Co. Galway


Joseph O Brien	Jimmy Green
PROJECT No.: 160815	0815 - 41
1:100 @A3	22.11.2018



McCarthy Keville O'Sullivan Ltd.
Planning & Environmental Consultants

Block 1, Galway Financial Services Centre, Moneenageisha Road, Galway, Ireland.


# Cross Section A-A (Scale 1:600 @ A3 ) Sec construction note 1 Sec construction note 1 Sec construction note 4 Sec construction note 5 Sec construction note 5 Sec construction note 5 Sec construction note 6 Sec con

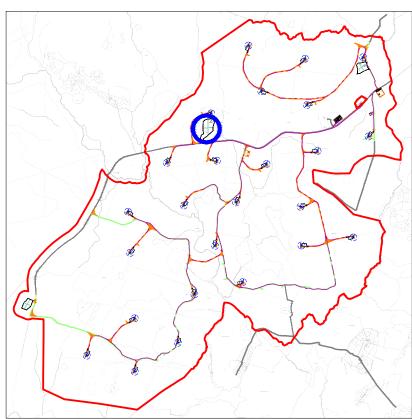

1:50,000 Location on Context Map

#### **Construction Notes:**


- (1) Exposed rock slopes formed at shallower inclinations (typically 60°) with face left irregular with declivities to promote re-vegetation and provide a naturalistic appearance (slope face exaggerated in section).
- (2) Engineered rock buttress left in-situ between cells of placed peat.
- (3) Footprint of quarry should be optimised to avoid areas of deeper peat.
- (4) In-situ rock slope formed at stable inclinations to suit local rock conditions.
- (5) Geogrid placed to strengthen surface of placed peat, as required.
- (6) Localised deepening of quarry floor to suit extraction operations, as required.
- (7) The location of the rock buttresses shown for the borrow areas are indicative only and may change subject to local conditions encountered on site during construction.
- (8) The excavatability of the rock and depth to top of rock within each of the borrow areas will need to be determined from a ground investigation.
- (9) Further guidelines on the construction of the borrow areas is included within Section 7.4 of the Peat Management Plan.

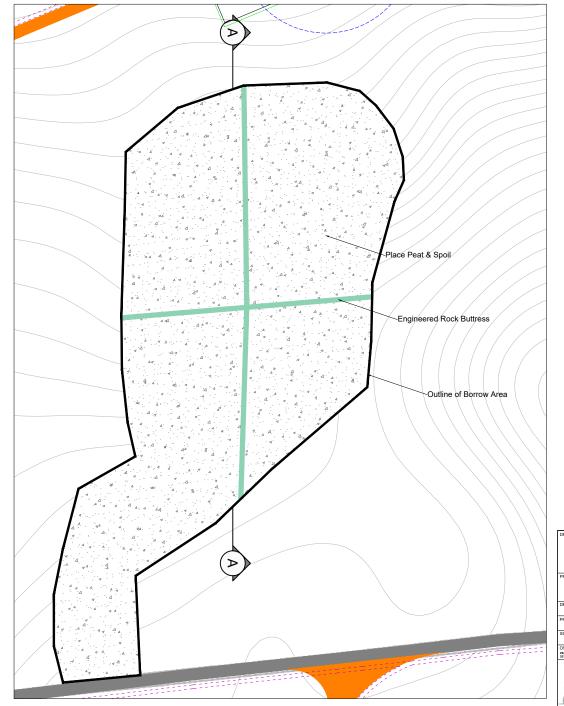

Borrow Pit No. 1 Scale 1:2,000


## Borrow Pit 1 Layouts & Sections


Gerry Kane	Paul Jennings
PROJECT No.: 1436_0586	0815 - 42
As Shown @A3	22.11.2018

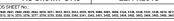



#### Cross Section B-B (Scale 1:500 @ A3)

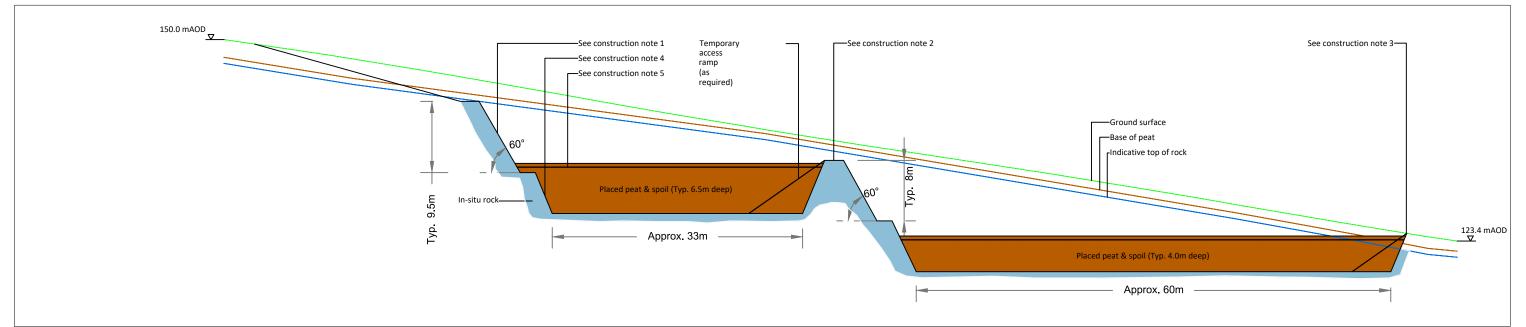


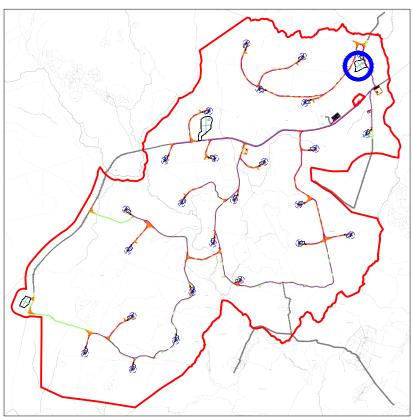


1:50,000 Location on Context Map

#### **Construction Notes:**


- (1) Exposed rock slopes formed at shallower inclinations (typically 60°) with face left irregular with declivities to promote re-vegetation and provide a naturalistic appearance (slope face exaggerated in section).
- (2) Engineered rock buttress left in-situ between cells of placed peat.
- (3) Footprint of quarry should be optimised to avoid areas of deeper peat.
- (4) In-situ rock slope formed at stable inclinations to suit local rock conditions.
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- (8) The excavatability of the rock and depth to top of rock within each of the borrow areas will need to be determined from a ground investigation.
- (9) Further guidelines on the construction of the borrow areas is included within Section 7.4 of the Peat Management Plan.

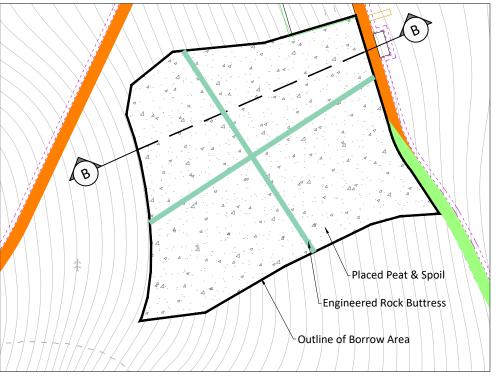


Borrow Pit No. 2 Scale 1:2,000

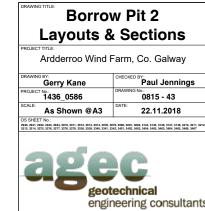

#### Cross Section C-C (Scale 1:400 @ A3)

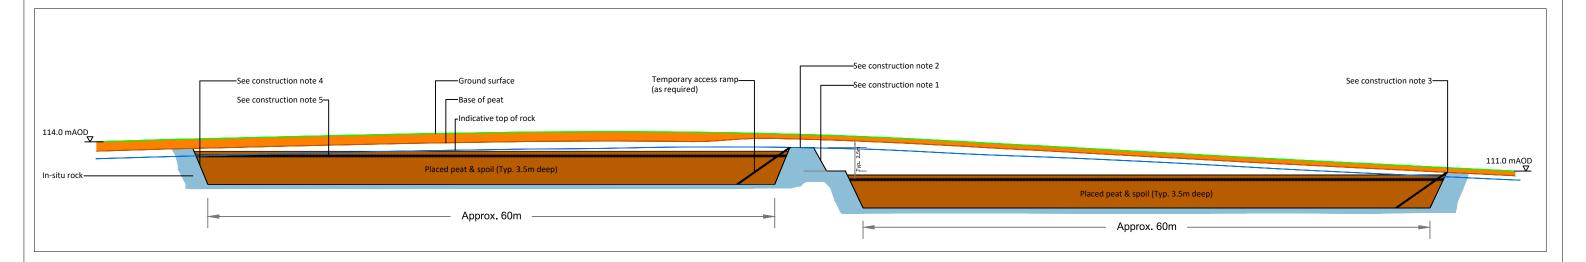


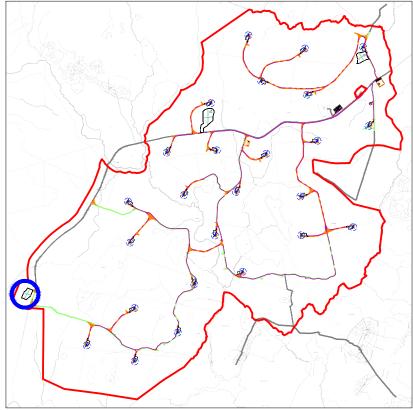


1:50,000 Location on Context Map

#### Construction Notes:

- (1) Exposed rock slopes formed at shallower inclinations (typically 60°) with face left irregular with declivities to promote re-vegetation and provide a naturalistic appearance (slope face exaggerated in section).
- (2) Engineered rock buttress left in-situ between cells of placed peat.
- (3) Footprint of quarry should be optimised to avoid areas of deeper peat.
- (4) In-situ rock slope formed at stable inclinations to suit local rock conditions.
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- (9) Further guidelines on the construction of the borrow areas is included within Section 7.4 of the Peat Management Plan.

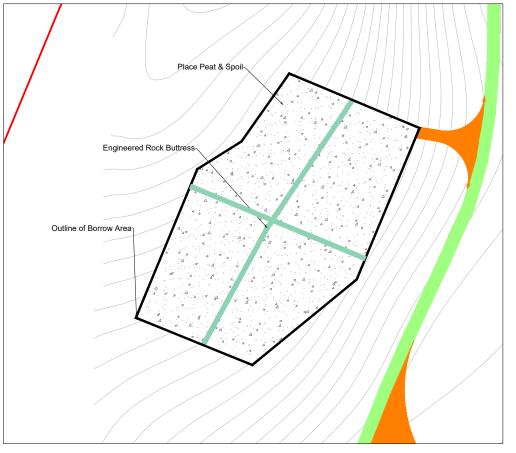



Borrow Pit No. 3 Scale 1:2,000

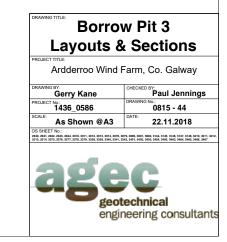

Drawing Notes

The final ground level will be determined by actual ground conditions and may differ from those stated on the drawings.

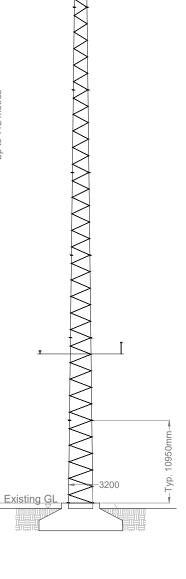

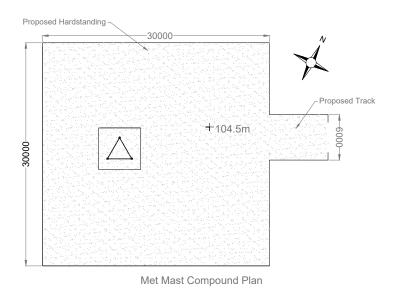

#### Free Standing **Anemometry Mast**


Ardderroo Wind Farm, Co. Galway


Joseph O Brien	Eoin McCarthy
PROJECT No.: 160815	0815 - 45
1:500 @A3	22.11.2018



McCarthy Keville O'Sullivan Ltd.
Planning & Environmental Consultants
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website: www.mccarthykos.ie
Tel: +353 91 735611
Fax: +353 91 771279

### **Drawing Notes** 1. Typical Layout, final dimensions and configuration will be based natural slope of on manufacturer's specifications local topography natural slope of local topography 3000 + - 40000 -Temporary Works Area Blade Set Down Area -13000 -Secondary Hardstand Temporary Works Area Secondary Hardstand Turbine Foundation Main Hardstand` - Turbine Excavation Area Positive drainage from turbine base - 55000 -DRAWING LEGEND SETTLEMENT POND - VEGETATION FILTER - LEVEL SPREADER CHECK DAM 'TYPE B' CHECK DAM 'TYPE B' Outfalls to proposed drainage or new outfall to lower ground depending on site topography INTERCEPTOR DITCH CULVERT □□□□ COLLECTOR DITCH CULVERT OVERLAND FLOW DISCHARGE TREATED WATER DISCHARGE North point will vary depending on turbine location, SETTLEMENT POND please refer to individual layout maps. SEMI-NATURAL VEGETATION SWALE / FILTER BED /SECONDARY SP VS - Treatment at outfall, if connection to proposed turbine drainage not possible **Typical Turbine Hardstand Layout Standard Detail** Ardderroo Wind Farm, Co. Galway Eoin McCarthy Joseph O Brien 160815 0815 - 46 1:500 @A3 22.11.2018 McCarthy Keville O'Sullivan Ltd. Planning & Environmental Consultants Block 1, Galway Financial Services Centre, Moneenageisha Road, Galway, Ireland. email: info@mccarthykos.ie website: www.mccarthykos.ie Tel: +353 91 735611 Fax: +353 91 771279

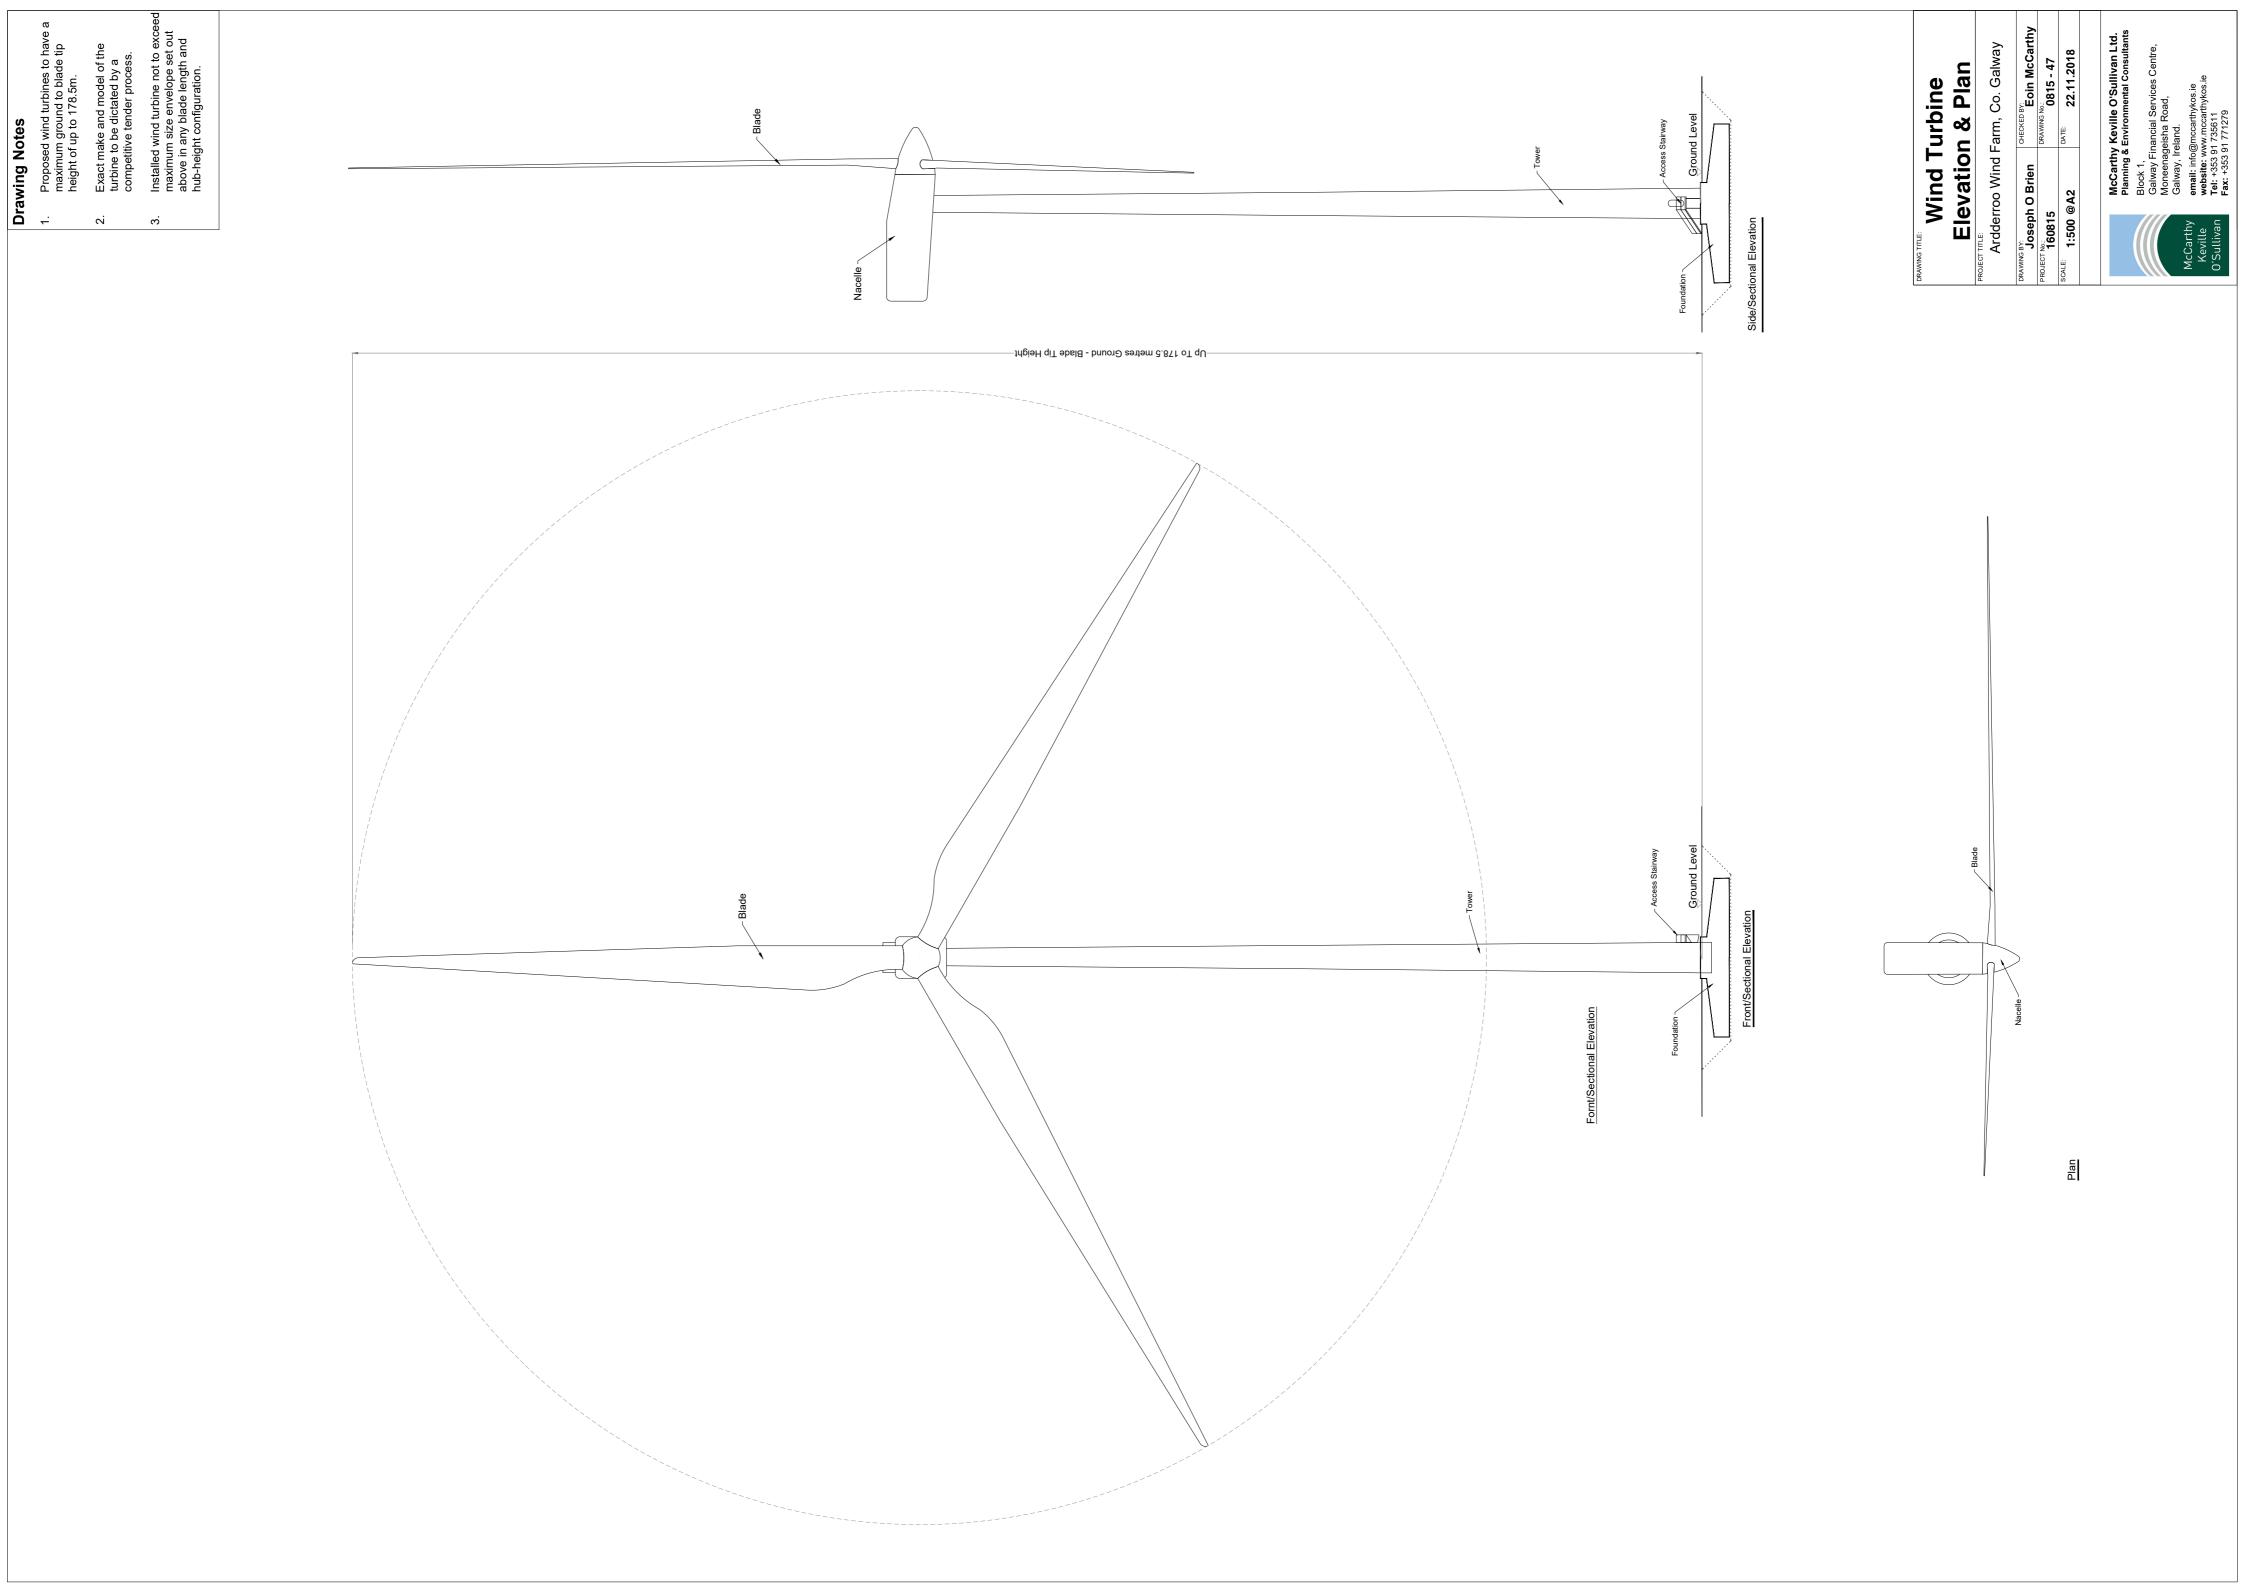

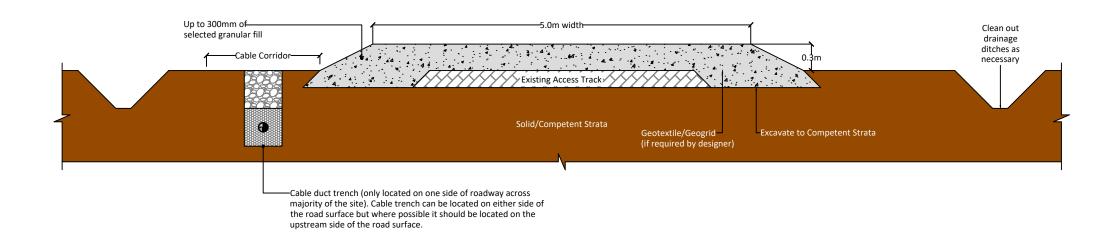

# Road Type A - Upgrade of Existing Excavated Access Track

Ardderroo Wind Farm,

Co. Galway

RAWING BY:

Gerry Kane


CHECKED BY:

DRAWING No.

DRAWING No.

Gerry Kane	Paul Jennings
PROJECT No.: 1436_0586	0815 - 48
1:50 @ A3	DATE: 22.11.2018
OS SHEET No.:	•



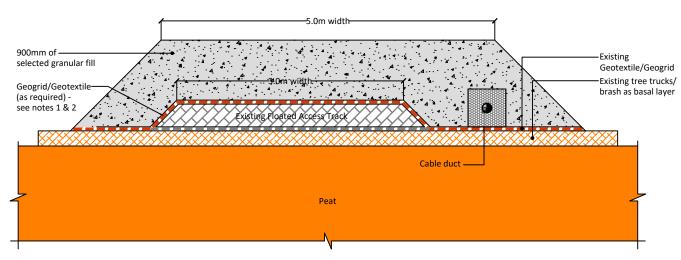


- Where coarse granular fill has been used in the existing floated access road make-up, a layer of geogrid should be placed on top of the existing floated access track.
   Where fine granular/cohesive type material has been used in the existing floated access road make-up (as is the case on some of the existing access roads in the southeast of the site), a layer of geotextile is likely to be required as a separator layer with a layer of geogrid.

## Road Type B - Upgrade of Existing Floated Access Track

Gerry Kane	Paul Jennings
PROJECT No.: 1436_0586	0815 - 49
SCALE: 1:50 @ A3	22.11.2018
1:50 @ A3	22.11.2018




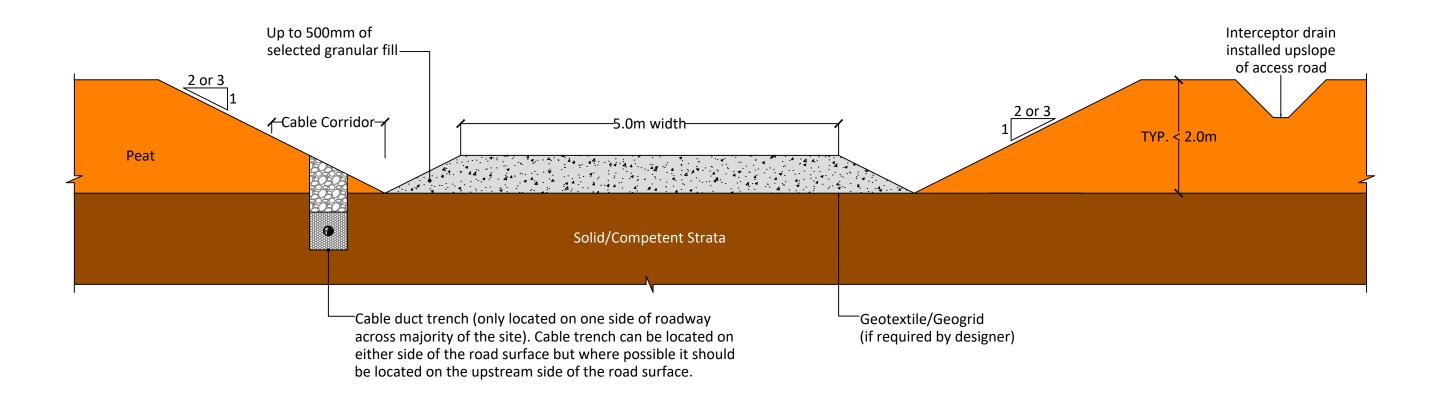

## Road Type C - New Excavated & Replace Access Road

Gerry Kane	Paul Jennings
PROJECT No.: 1436_0586	0815 - 50
SCALE: 1:50 @ A3	DATE: 22.11.2018
OS SHEET No.:	-



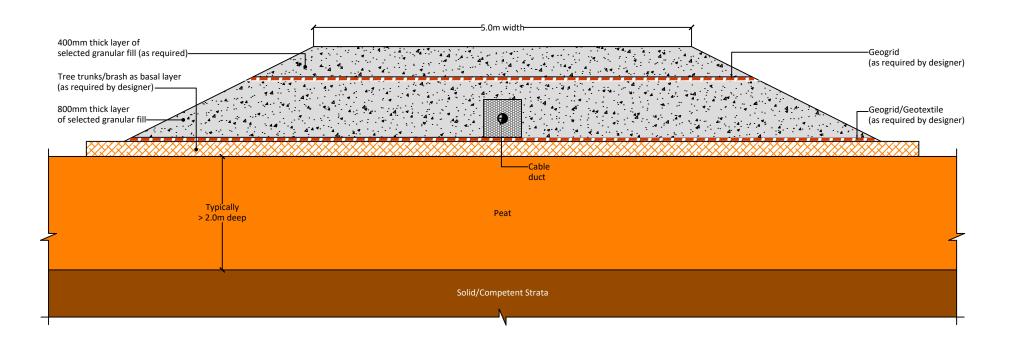

#### RAWING TITLE:

#### Road Type D - New Floated Access Track

Gerry Kane	Paul Jennings
PROJECT No.: 1436_0586	DRAWING No.: 0815 - 51
1:50 @ A3	22.11.2018
OS SHEET No.:	•





- dimensions and levels that relate to the works.

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  7. Layout plans show typical Turbine rotor diameter as per turbine drawing.

  8. Final levels may vary depending on local ground conditions.

#### Proposed Amenity & **Recreation Car Park**


Ardderroo Wind Farm, Co. Galway

Joseph O Brien	Jimmy Green
PROJECT No.: 160815	0815 - 52
1:250 @A3	22.11.2018

OS SHEET No.: 2600, 2611, 2612, 2614, 3010, 3011, 3012, 3013, 3014, 3016, 3007, 3009, 3009, 3009, 3014, 3144, 3146, 3146, 3147, 3146, 3210, 2011, 3012, 3011, 3012, 3010, 3009, 3001, 3009, 3044, 3145, 3146, 3146, 3147, 3146, 3210, 2011, 3012, 3012, 3012



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  4. Do not scale off this drawing. Figured metric dimensions only should be taken off this drawing.
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  6. The use of or reliance upon this drawing shall be deared to be
- dimensions and levels that relate to the works.

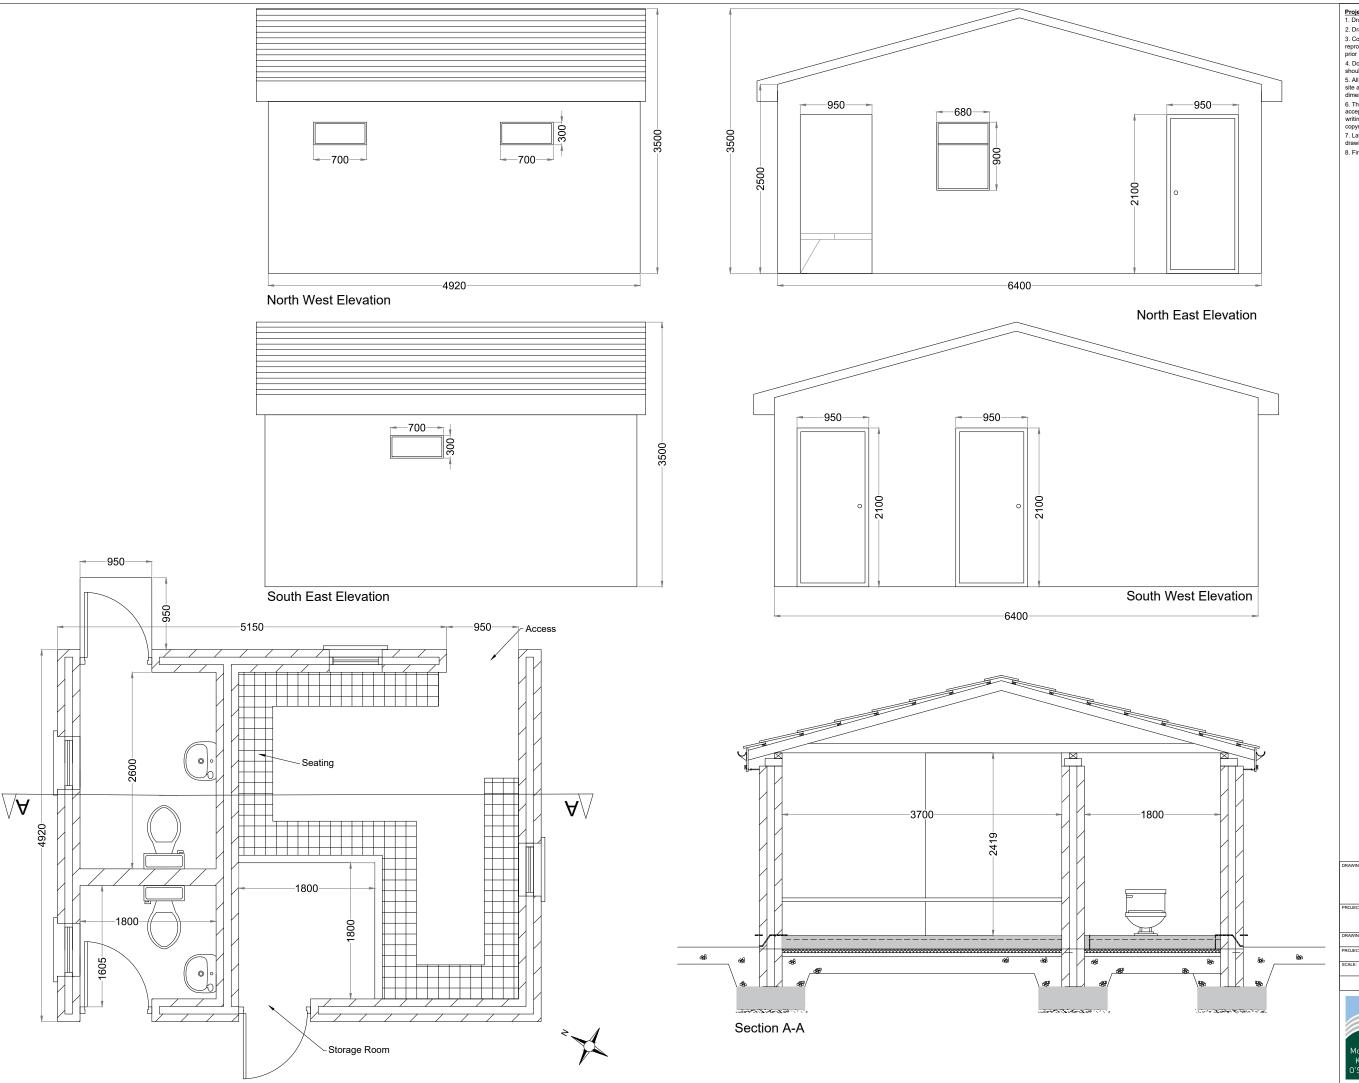  6. The use of or reliance upon this drawing shall be deemed to be acceptance of these conditions of use unless otherwise agreed in writing, such written agreement to be sought from and issued by the copyright holder to the use or reliance upon this drawing.

  7. Layout plans show typical Turbine rotor diameter as per turbine drawing.

  8. Final levels may vary depending on local ground conditions.

#### **Toilets Layout and Elevations**


Ardderroo Wind Farm, Co. Galway

	Joseph O Brien	Jimmy Green
-	PROJECT No.: 160815	0815 - 53
-	1:50 @A3	22.11.2018




McCarthy Keville O'Sullivan Ltd. Planning & Environmental Consultants


Block 1, Galway Financial Services Centre, Moneenageisha Road, Galway, Ireland.

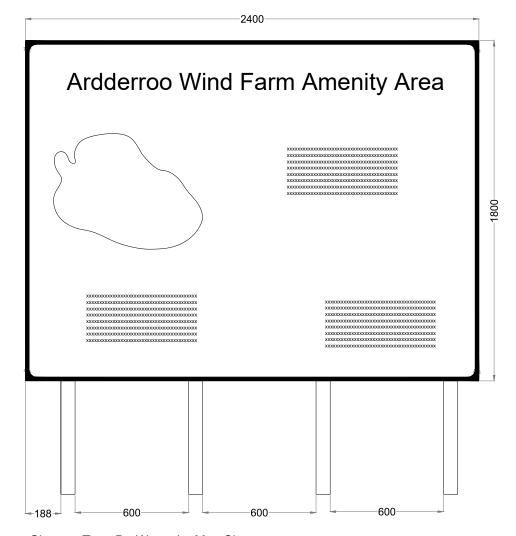


Signage Type B - Waypoint Map Signage

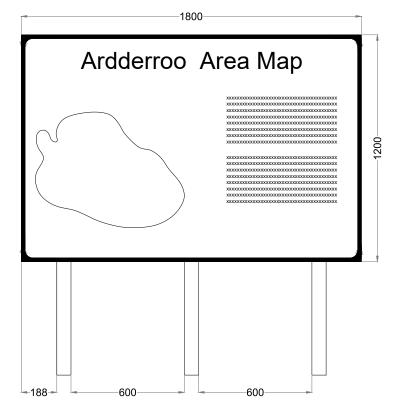

Signage Type A - Entry Point Signage

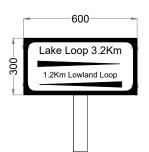



Signage Type C - Way Point Direction Signage

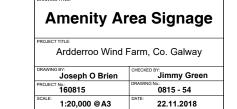



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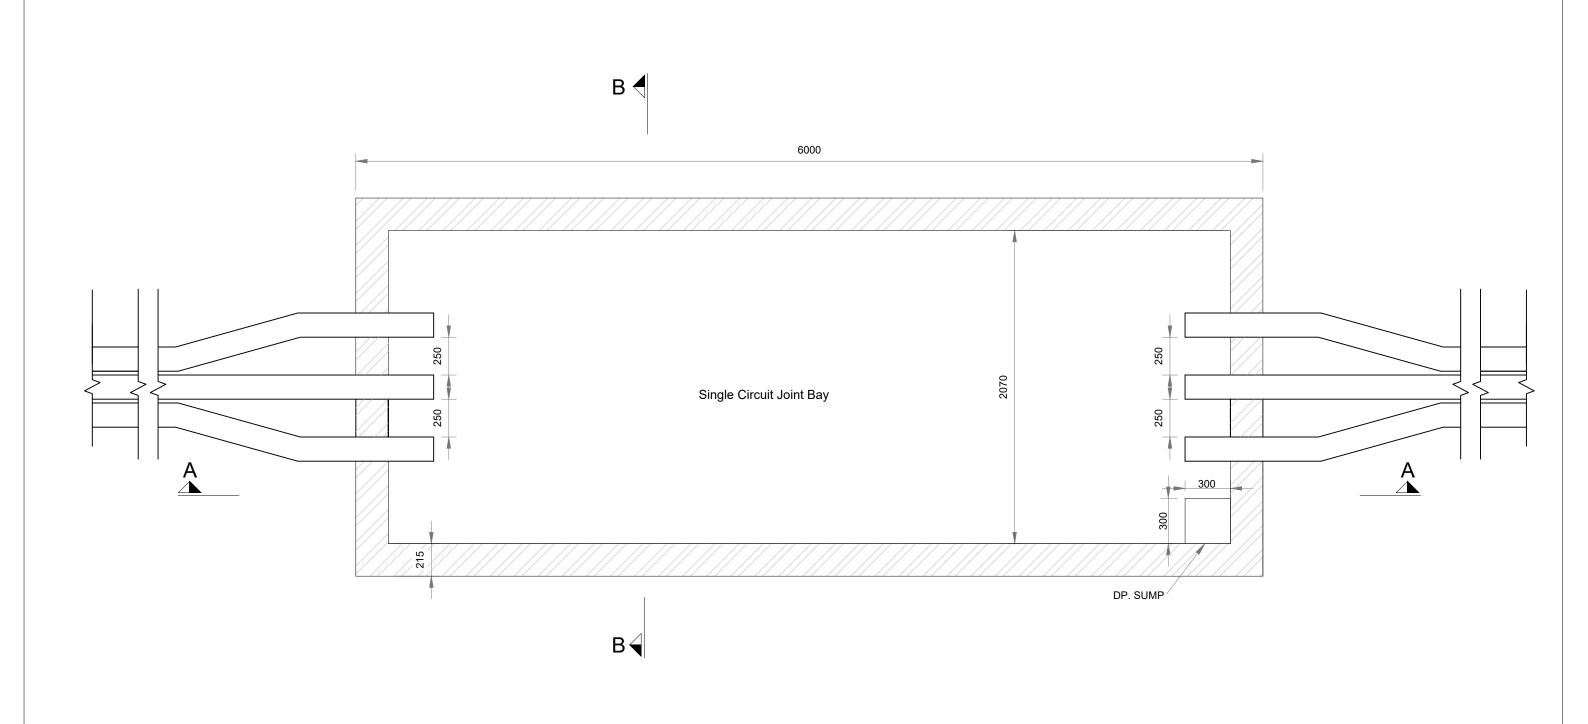
## Typical Clear Span Watercourse Crossing Detail & Cross Section

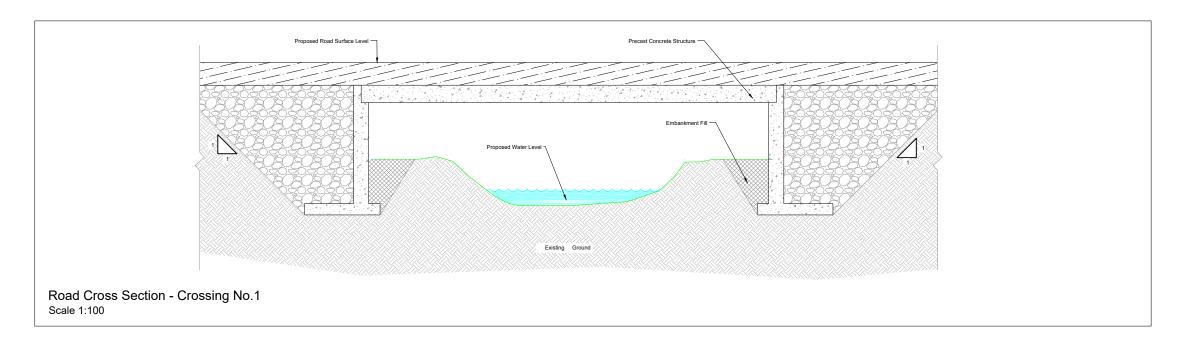Ardderroo Wind Farm, Co. Galway

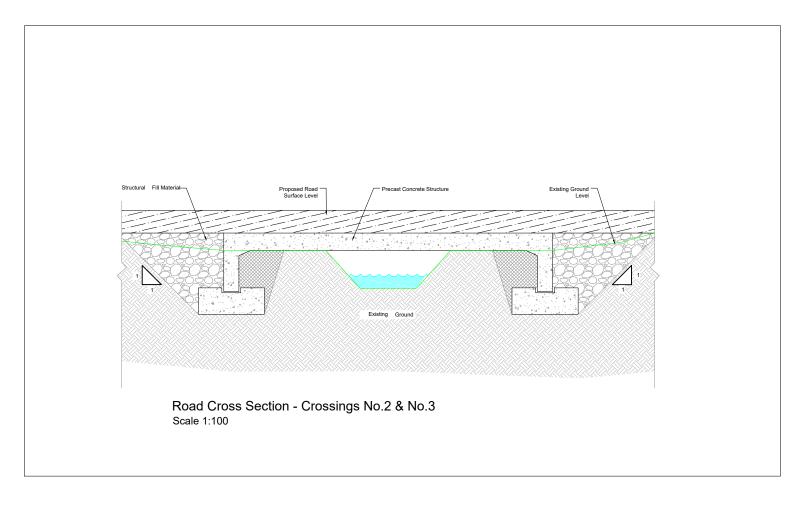Joseph O Brien	Jimmy Green
PROJECT No.: 160815	0815 - 55
1:100 @A3	22.11.2018



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# Typical Joint Bay Details - Sheet 1 of 3


Ardderroo Wind Farm, Co. Galway


Joseph O Brien	Jimmy Green
PROJECT No.: 160815	DRAWING No.: 0815 - 56
1: 25 @ A3	22.11.2018




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Planning & Environmental Consultan Block 1, Galway Financial Services Centre, Moneenageisha Road, Galway, Ireland. emall: info@mccarthykos.ie website: www.mccarthykos.ie Tel: +353 91 735611 Fax: +353 91 771279



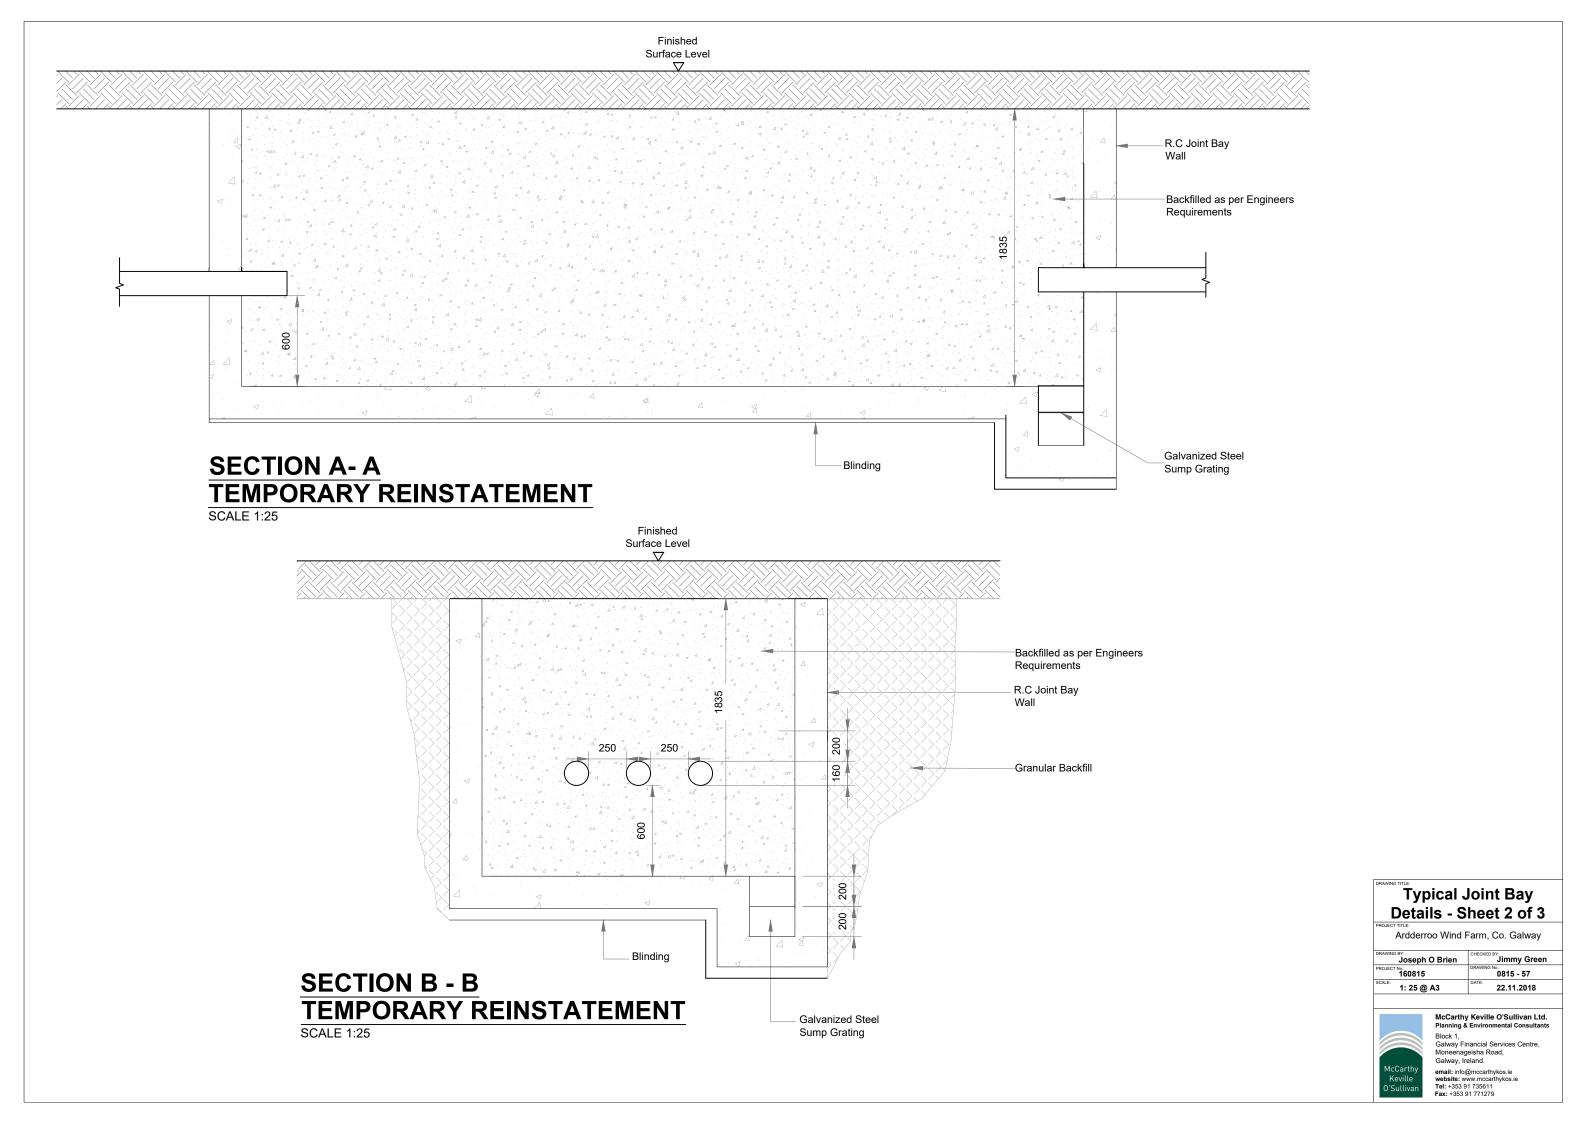

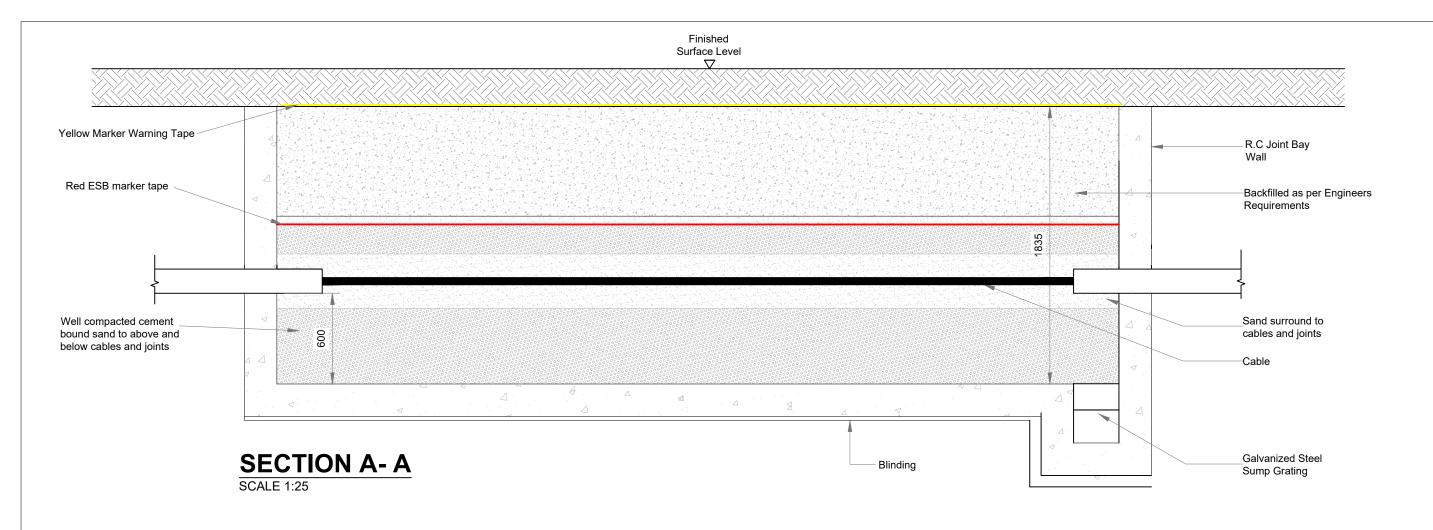
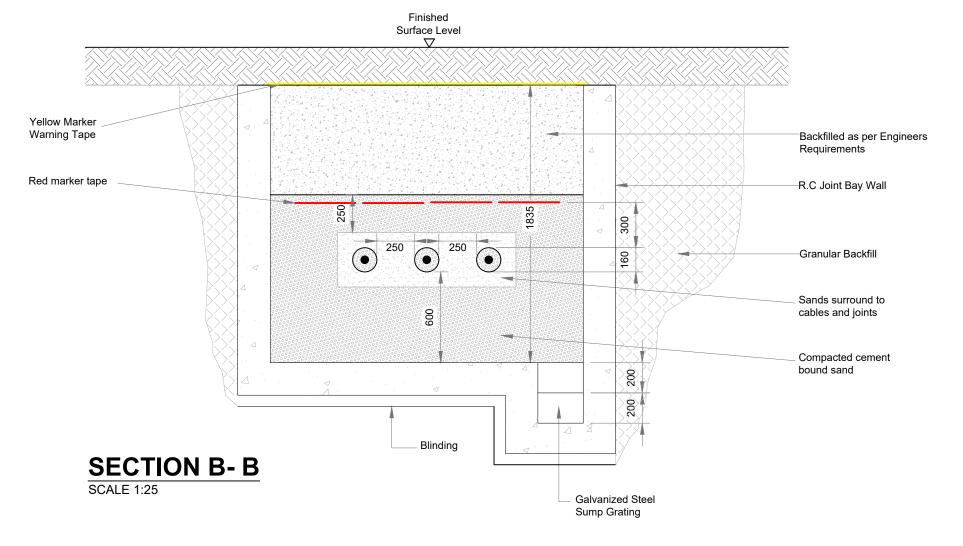
## Typical Joint Bay Details - Sheet 3 of 3


Ardderroo Wind Farm, Co. Galway


Joseph O Brien	Jimmy Green
PROJECT No.: 160815	0815 - 58
1: 25 @ A3	22.11.2018



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Moneenageisha Road, Galway, Ireland. email: info@mocarthykos.ie website: www.mccarthykos.ie Tel: +353 91 735611 Fax: +353 91 771279



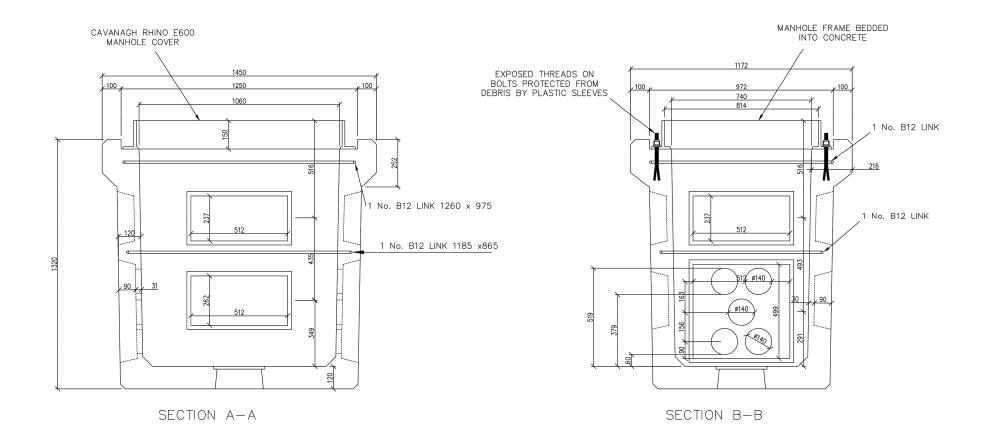
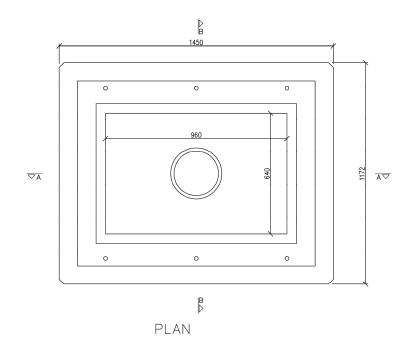
## Typical Comms Chamber Detail


Ardderroo Wind Farm, Co. Galway

Joseph O Brien	CHECKED BY: Jimmy Green
PROJECT No.: 160815	DRAWING No.: 0815 - 59
1:20 @ A3	DATE: 22.11.2018



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# TYPICAL CROSS SECTION SCALE 1:10

## TYPICAL LONGITUDINAL SECTION SCALE 1:10

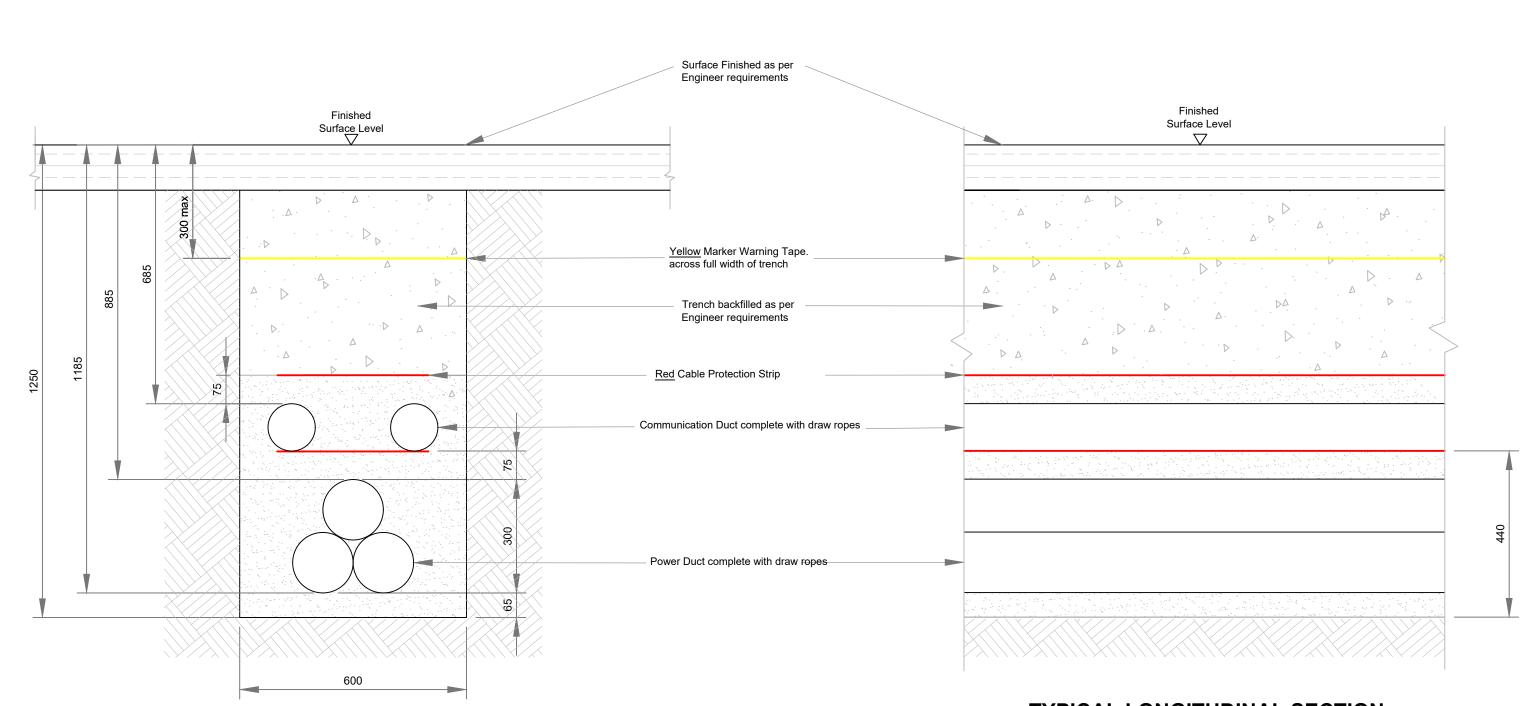


Ardderroo Wind Farm, Co. Galway


Joseph O Brien	Jimmy Green
PROJECT No.: 160815	0815 - 60
1:10 @ A3	22.11.2018



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# SECTION THRU' SERVICE / CROSSING SCALE 1:25

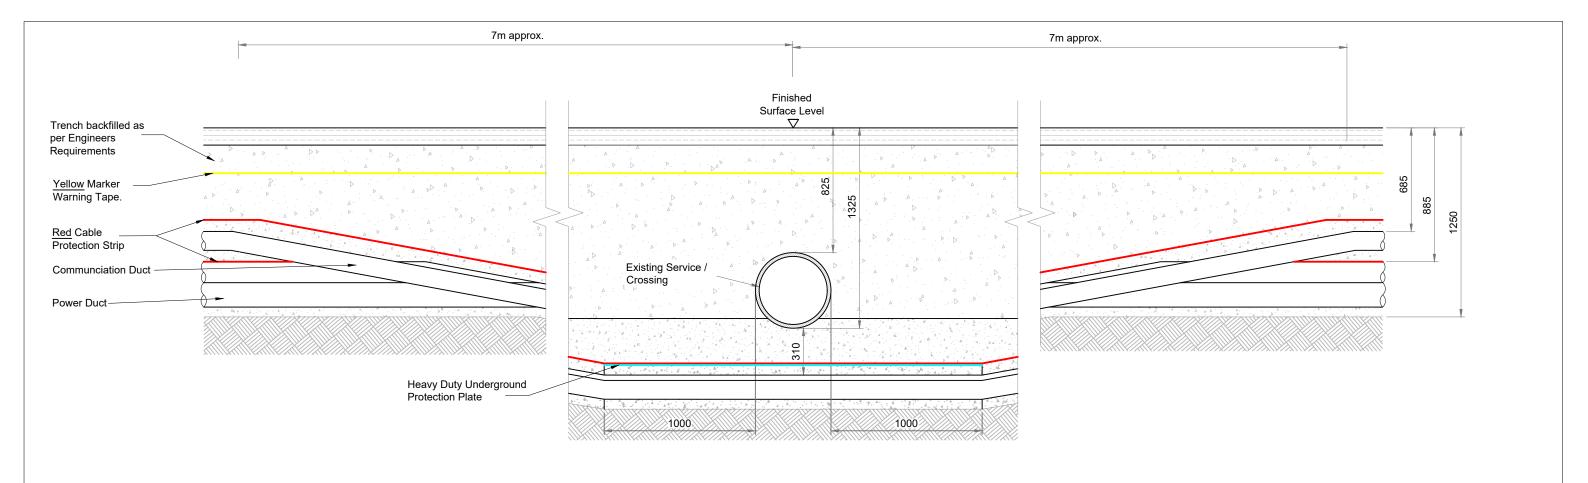

## **SECTION THRU' DUCTING**

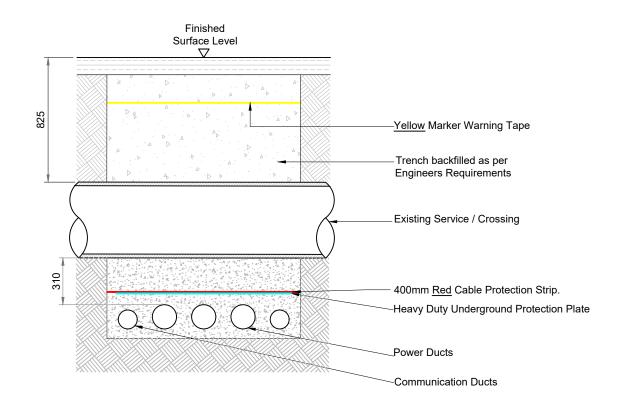SCALE 1:25


# Cable Trench Under Service/Crossing Flatbed Formation

Ardderroo Wind Farm, Co. Galway

Joseph O Brien	Jimmy Green
PROJECT No.: 160815	0815 - 61
1: 25 @ A3	22.11.2018




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## **SECTION THRU' SERVICE / CROSSING**

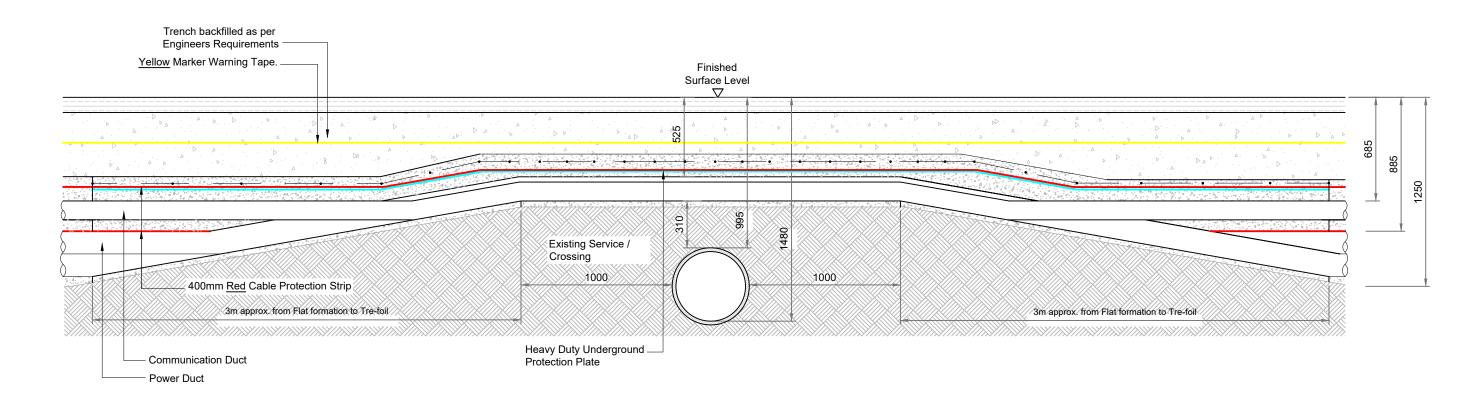SCALE 1:25



## **SECTION THRU' DUCTING**

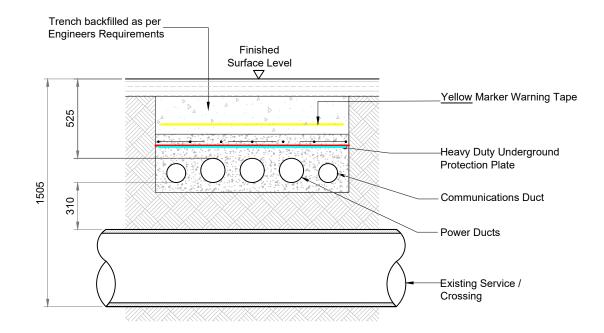SCALE 1:25

# Cable Trench Over Service/Crossing Flatbed Formation


Ardderroo Wind Farm, Co. Galway


Joseph O Brien	Jimmy Green
PROJECT No.: 160815	0815 - 62
1: 25 @ A3	DATE: 22.11.2018




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## Cable Trench Flatbed at Road Surface Level


Ardderroo Wind Farm, Co. Galway

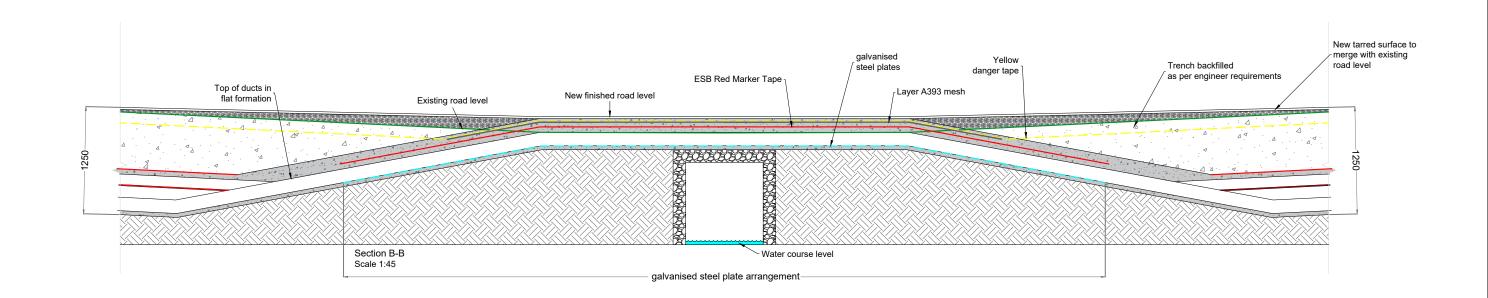Joseph O Brien	Jimmy Green
PROJECT No.: 160815	0815 - 63
As Shown @ A3	22.11.2018

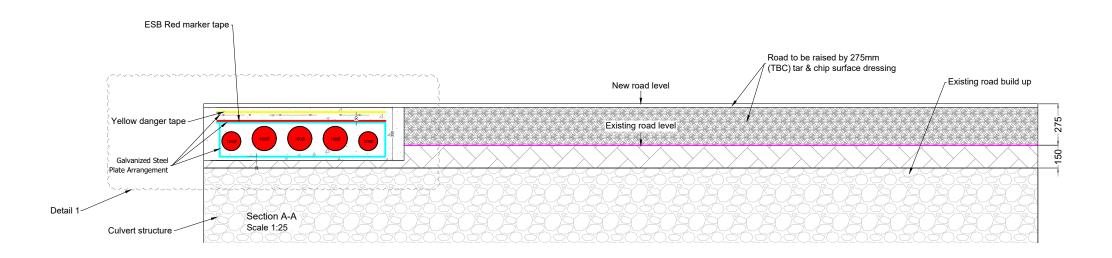

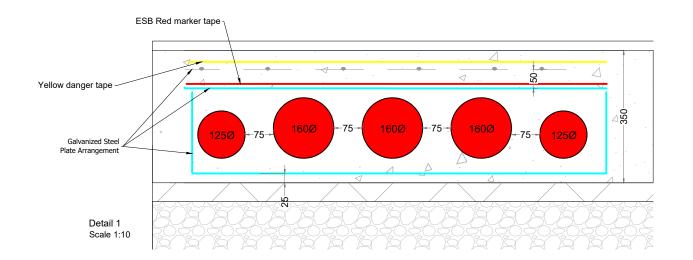
McCarthy Keville O'Sullivan Ltd.
Planning & Environmental Consultants
Block 1,
Galway Financial Services Centre

Block 1, Galway Financial Services Centre, Moneenageisha Road, Galway, Ireland. email: info@mccarthykos.ie website: www.mccarthykos.ie Telt: +353 91 775611 Fax: +353 91 771279

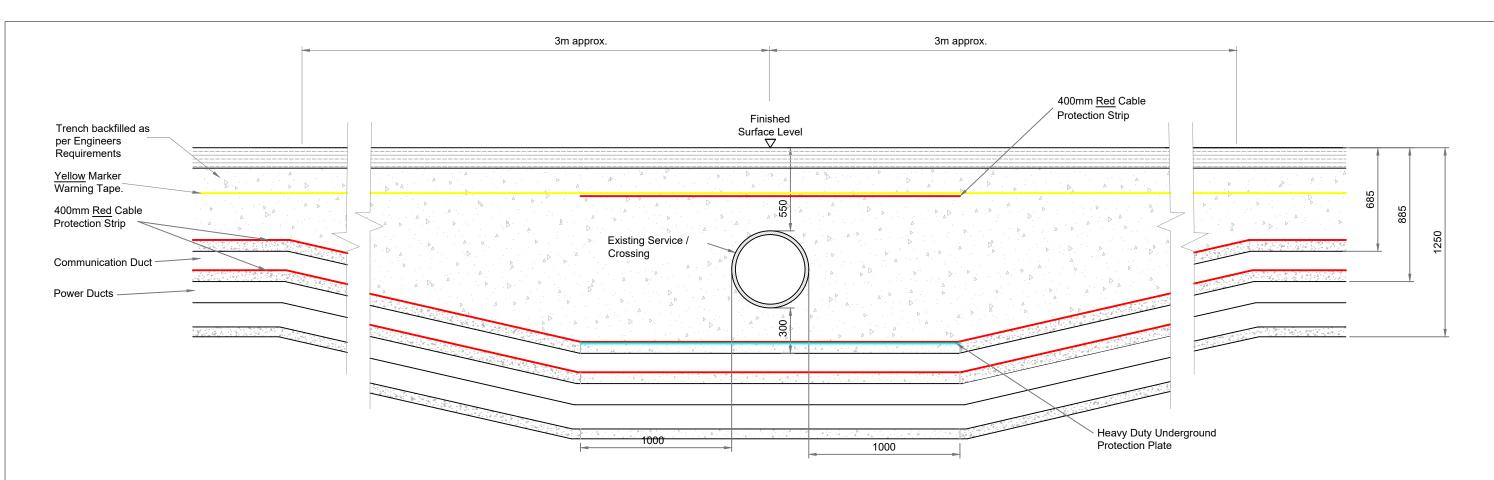

## **SECTION THRU' SERVICE / CROSSING**

SCALE 1:25

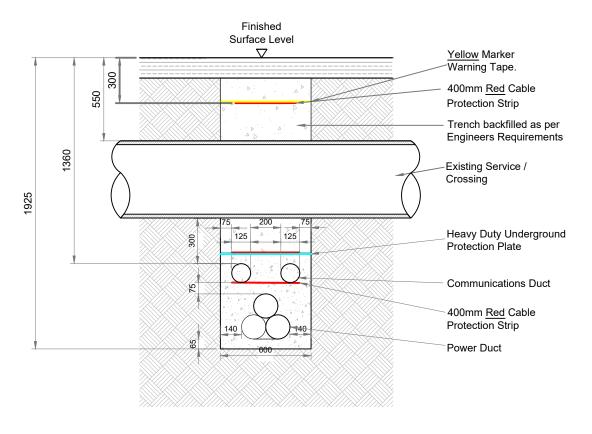

Cable Trench Under Service/Crossing Trefoil Formation


Ardderroo Wind Farm, Co. Galway

> BB G M G McCarthy Eville

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**SECTION THRU' DUCTING** 

SCALE 1:25



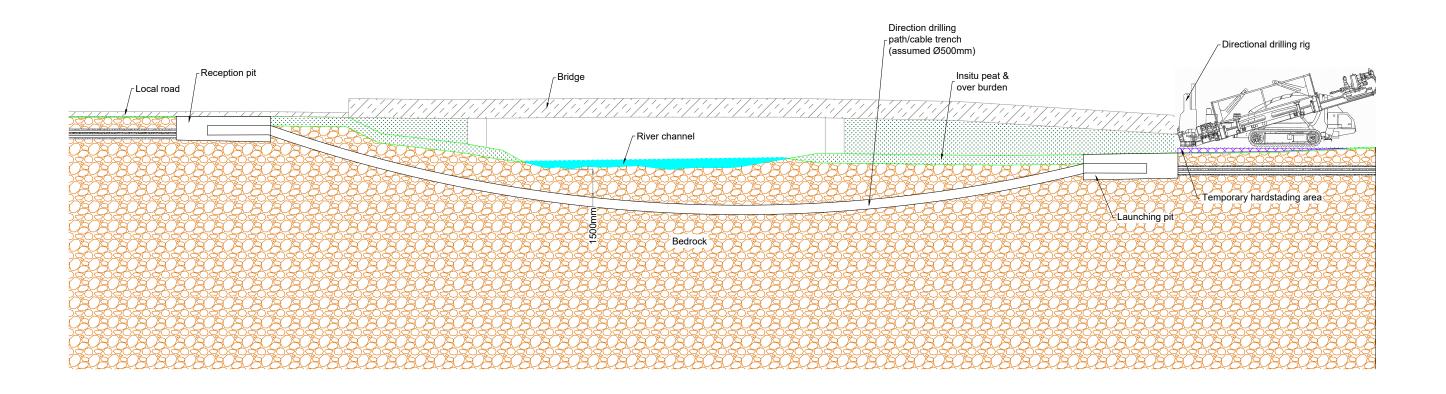

#### RAWING TITLE:

#### **Directional Drilling**


Ardderroo Wind Farm, Co. Galway

Joseph O Brien	Jimmy Green
PROJECT No.: 160815	0815 - 65
1:200 @ A3	22.11.2018



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## Horizontal Auger Drilling

#### \_

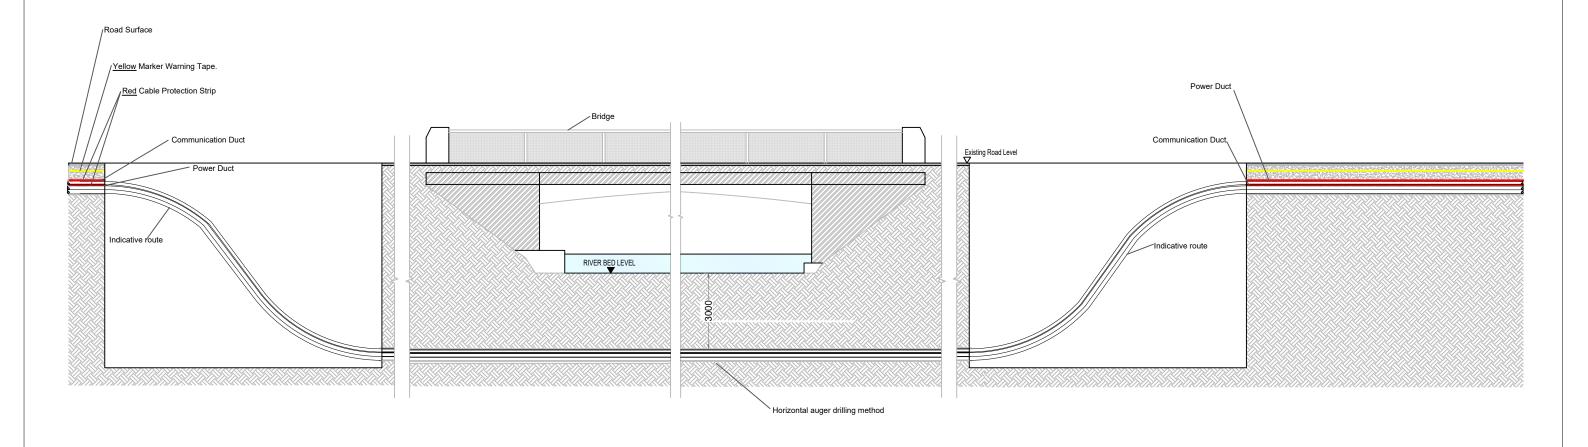
Ardderroo Wind Farm, Co. Galway


Joseph O Brien	Jimmy Green
PROJECT No.: 160815	0815 - 66
1: 150 @ A3	22.11.2018



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## Typical Cable Crossing Detail

Ardderroo Wind Farm, Co. Galway
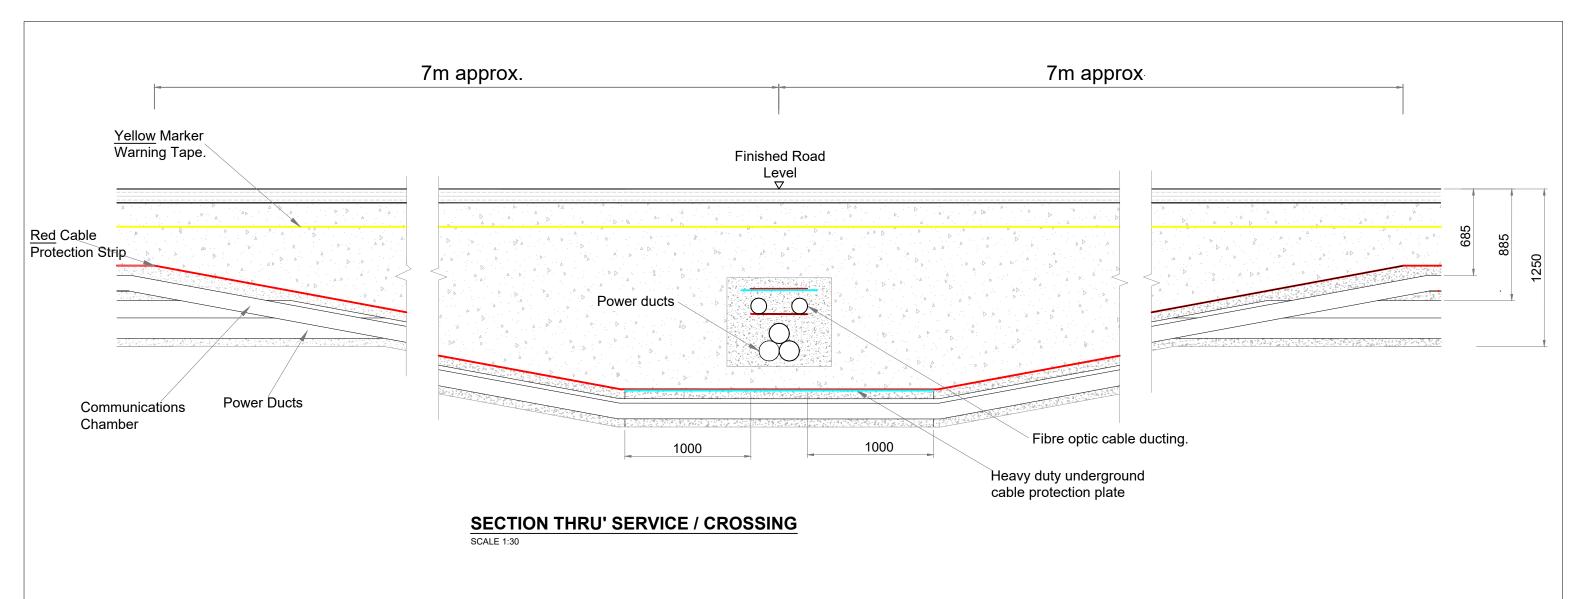
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PROJECT No.: 160815	0815 - 67
1:30 @ A3	22.11.2018

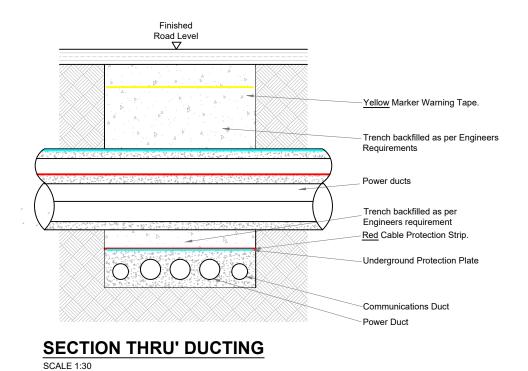

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